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Drawn by:

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CHOUINARD DESIGN STUDIO
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PLAN

EQUIPMENT

FOODSERVICE

JBM

3/1/2022

Sheet Number:

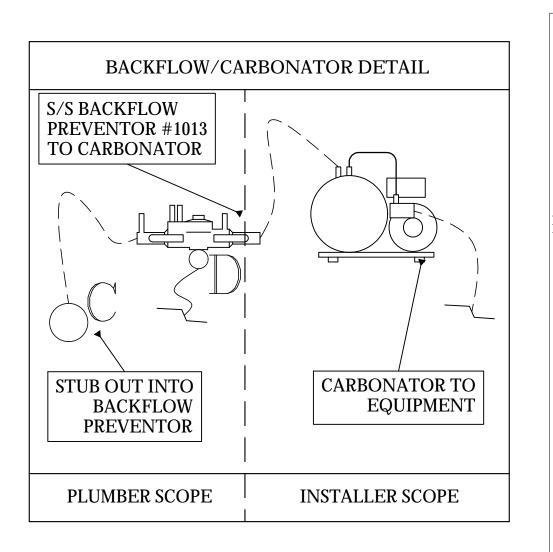
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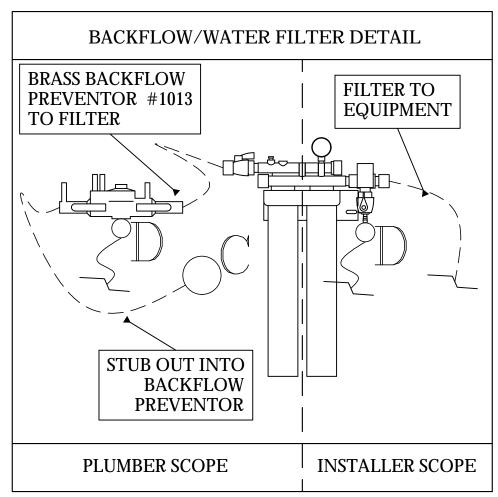
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| PROUIDED BY LECT LEUD CHIEFTELT AND PROVIDED BY LECT CHIEFTELT BY LICE CHIEFTELT BY LI | | | amants. | ,ęč, | | | | St. In Arts | | iste | akt 10 | Ark esite | ,e side | Roughinaft | Rift States |
| SO NOTO NOTO SURVISED | | iption | ornent Re | Hold Rife Dire | 18/ 250 | | | ica Rouse Ren | | Julater Site | nin Afth site Acute Hot Rough | IL OCH MOSEC | Naste Mast | Site Stone In | SMBTU GAS TYPE PLUTTING RETT. |
| ON SEQN SEQN SEEL, CROSS, Met | Mode | Desch | Edith | | | Phase Ari | | thedi | | cold, | HOT YOUR | ndire Direct | Direct Gar | 2/ 642/ 64 | SW 635 Philippi |
| X 100 1 By Vendor 101 1 Micro Matic | POSSYSTEM BG-U-12KR | POS System Draft Beer Dispensing Tower | w/ Glass Rinser in Drip Tray | X 5-15F | P 115 1 | 1 6 | 24" | | 1/2" | | 1" | | | | Glass Rinser w/ Pressure Reducer |
| 102 1 Turbo Air | TBC-36SB-GF-N | Glass Froster | | X 5-15F | P 115 1 | 1 1.6 | 1/3 24" | | 1,2 | | | | | | Glass Kinsel Wy Fressare Reader |
| 103 1 Oneida Hospitality 104 1 Turbo Air | FF_SSS TBB-24-72SGD-N | Underbar Shelving Unit Back Bar Cabinet, Refrigerated | See Written Specs for Configuration | X 5-15F | P 115 | 1 2.9 | 1/3 24" | | | | | | | | |
| 105 1 By Vendor | POSSYSTEM | POS System | | | | | | | | | | | | | |
| 106 1 Turbo Air 107 1 Krowne | TBC-65SB-N6 KR24-1C | Bottle Cooler Dump Sink | | X 5-15F | P 115 2 | 1 1.7 | 1/5 24" | | 1/2" | 15" 1/2 | " 15" 1 1/ <i>i</i> |)" | | | ABS to Floor Sink |
| 108 1 Krowne | GWH-24 | Glasswasher, Undercounter | | X | 208 | 1 32 | 18" | | 1/2 | | " 12" 1 1/2 | | | | Copper to Floor Sink |
| 109 1 Oneida Hospitality 110 1 Krowne | FF_SSS | Underbar Shelving Unit Hand Sink | See Written Specs for Configuration | | | | | | 1/2" | 15" 1/2 | " 15" | 1 1/2" 12 | יים | | ABS to Drain |
| 111 1 Krowne | KR24-12RD | Bottle Storage Unit | | | | | | | 1/2 | 13 1/2 | 15 | 1 1/2 12 | 2 | | Abs to Diam |
| 112 1 Krowne 113 1 Oneida Hospitality | KR19-36DP-10 FF SSS | Ice Bin Underbar Shelving Unit | See Written Specs for Configuration | | | | | | | | 1" | | | | ABS to Floor Sink |
| X 114 2 By Vendor | POSSYSTEM | POS System | See Written Specs for Configuration | X 5-15F | P 115 2 | 1 6 | 24" | | | | | | | | |
| 200 1 Advance Tabco 201 1 Advance Tabco | DT-6R-21 | Dishtable Sorting Shelf | Mount @ 54" to Bottom of Shelf | | | | | | | | 1 1/2 |) II | | | ABS to Floor Sink |
| 201 1 Advance Tabco 202 1 T&S Brass | DTS-S30-60R B-0133-B | Soiled Dishtable Pre-Rinse Faucet | | | | | | | 1/2" | 24" 1/2 | | 4 | | | ABS to Floor Sifik |
| X 203 1 CMA Dishmachines | C | Dishwasher, Corner | | X | 115 | 1 16 | 1 66" | | | 1/2 | " 60" 1 1/2 | 2" | | | Copper to Floor Sink |
| 204 1 Advance Tabco 205 1 Advance Tabco | DTC-S30-60L DT-6R-22 | Clean Dishtable Glass Rack Shelf, 42" | Mount @ 54" to Bottom of Shelf | | | | | | | | | | | | |
| 206 1 Thunder Group | CMEP_ | Pot/Pan Shelving | See Written Specs for Configuration | | | | | | | | | | | | |
| 207 1 Thunder Group 208 1 Advance Tabco | CMSV_+WB_ 7-PS-23-EC-SP-1X | Overhead Shelving Hand Sink | Mount @ 84" to Bottom of Bracket Mount @ 34" to Top of Sink | | | | | | 1/2" | 21" 1/2 | " 21" | 1 1/2" 18 | 8" | | |
| 209 1 Advance Tabco | FC-3-1818-18RL-X | 3 Comp Sink, 18"x18" Bowls | | | | | | | | | | | | | ADC to Floor Circle |
| 210 3 T&S Brass 211 1 T&S Brass | B-3950 B-0231 | Twist Waste Valve Wall Mount Faucet | | | | | | | 1/2" | 21" 1/2 | " 21" | - | | | ABS to Floor Sink |
| 212 1 Advance Tabco 213 1 Thunder Group | PS-15-96 CMSV +WB | Overshelf Overhead Shelving | Mount @ 72" to Shelf Mount @ 84" to Bottom of Bracket | | | | | | | | | | | | |
| 300 1 Thunder Group | CMSV_+WB_ | Overhead Shelving Overhead Shelving | Mount @ 84" to Bottom of Bracket | | | | | | | | | | | | |
| X 301 1 By Vendor | 631100057 | Soda Dispenser, In-Counter | | X 5-15F | P 115 2 | 1 1.5 | 18" | | | | 1" | | | | PVC to Floor Sink |
| X 302 1 JDI X 303 1 BUNN | SSBEVCOUNTER 36700.0009 | Beverage Counter Iced Tea Brewer | | X 5-15F | P 120 1 | 1 14.4 | 4 48" | | 1/2" | 48" | | | | | Requires #1022 Back Flow Preventor |
| X 304 1 BUNN | 36900.0000 | Coffee Dispenser | | X 5-15F | P 120 2 | 1 15 | 48" | | 1/2" | 48" | | | | | Requires #1022 Back Flow Preventor |
| 305 1 Advance Tabco 306 1 Advance Tabco | WS-15-36 WS-12-36 | Wall Shelf, 15"x36" Wall Shelf, 12"x36" | Mount @ 60" to Shelf Mount @ 75" to Shelf | | | | | | | | | | | | |
| 307 1 Advance Tabco | DI-1-10SP | Drop In Sink, 10"x14" Bowl | | | | | | | 1/2" | 18" 1/2 | " 18" | 1 1/2" 15 | 5" | | |
| 308 1 JDI 309 2 Advance Tabco | SSPASSTHRUTRPL EDC-1572-X | Pass Thru Shelf Dish Cabinet | | | | | | | | | | | | | |
| 400 1 T&S Brass | B-0228-CR | Deck Mount Faucet | | | | | | | 1/2" | 21" 1/2 | " 21" | | | | |
| 401 1 Advance Tabco 402 1 T&S Brass | KMS-304 B-3950 | Work Table, 30"x48" w/ PREP Sink Twist Waste Valve | | | | | | | | | 1 1/2 | 2" | | | ABS to Floor Sink |
| 403 1 ACP | RCS10TS | Microwave Oven | NATURE OF TAILED Chalf | X 5-15F | P 120 1 | 1 13 | 66" | | | | | | | | |
| 404 1 Advance Tabco 405 1 Hatco | MS-18-24-EC-X GRAH-54D3 | Microwave Oven, Shelf Heat Lamp | Mount @ 54" to Shelf | X | 208 | 1 8.9 | 60" | Run Whip from Window Opening Under Middle Shelf | | | | | | | |
| 406 1 Turbo Air | TST-60SD-16-N | Sandwich Prep Refrigerator | | X 5-15F | | 1 4.4 | - ' - | | | | | | | | |
| 407 1 Vollrath 408 1 T&S Brass | 38217 B-0580 | Hot Food Serving Table Filler Faucet | | X 6-30F | 208 | 1 10 | 18" | | | 1/2 | " 38" | | | | |
| 409 1 Turbo Air | TST-60SD-16-N | Sandwich Prep Refrigerator | NATURE OF SAILES Chalf | X 5-15F | P 115 2 | 1 4.4 | 1/3 24" | | | | | | | | |
| | MS-18-24-EC-X RCS10TS | Microwave Oven, Shelf Microwave Oven | Mount @ 54" to Shelf | X 5-15F | P 120 1 | 1 13 | 66" | | | | | | | | |
| 412 1 Krowne | KR24-12ST | Hand Sink | | V 5.455 | 2 445 | 1 63 | 2/2 40" | | 1/2" | 15" 1/2 | " 15" | 1 1/2" 12 | 2" | | |
| | M3F47-2-N G32D5 | Reach-In Freezer Convection Oven, Gas | w/ Quick Disconnect Gas & Water Hose | X 5-15F X 5-15F | | 1 6.3 1 1 | 2/3 48" 48" | | 1/2" | 48" | | | 1/2" | 36" 33k | NAT |
| 415 1 Imperial | IR-6-C | Range, 36", 6 Burners w/ Convection Oven | w/ Quick Disconnect Gas Hose | X 5-15F | P 115 1 | 1 6 | 1/2 24" | | | | | | 3/4" | 30" 222k | NAT |
| 416 1 Imperial 417 1 Turbo Air | IAB-48 TCBE-48SDR-N | Charbroiler, Gas, Countertop Equipment Stand, Refrigerated Base | w/ Quick Disconnect Gas Hose | X 5-15F | P 115 1 | 1 3 | 1/4 24" | | | | | | 3/4" | 30" 160k | INA I |
| 418 1 Imperial | ITG-60 | Griddle, Gas, Countertop | w/ Quick Disconnect Gas Hose | | | | | | | | | | | 30" 150k | |
| | IRSB-36 PRCBE-60R-N | Salamander Broiler, Gas Equipment Stand, Refrigerated Base | Mount @ 54" to Bottom | X 5-15F | P 115 1 | 1 3.2 | 1/4 24" | | | | | | 3/4" | 76" 40k | INA I |
| 421 1 Imperial | IFS-50 | Fryer, 50lb | w/ Quick Disconnect Gas Hose | | | | | | | | | | 3/4" | 18" 140k | NAT |
| 422 1 Turbo Air 423 1 Advance Tabco | TST-28SD-12-N WS-15-36 | Mega Top Sandwich Prep Refrigerator Wall Shelf, 15"x36" | | X 5-15F | 115 | 3.8 | 1/5 24" | | | | | | | | |
| 424 1 Advance Tabco | KMS-302 | Work Table, 30"x24" | | V 0.25 | 200 | 1 | 40" | | | | | | | | |
| 425 1 Bakers Pride 500 1 Advance Tabco | P18S FFTG-1836 | Pizza Bake Oven, Countertop, Electric Floor Trough, 18"x36" | | X 6-15F | 208 | 1 14 | 48" | | | | | 4" -6 | 6 | | |
| 501 1 Follett | SG1000S-36 | Ice Bin, 1000 lb | | | | | | | | | 1" | | | | PVC to Floor Trough |
| 502 1 Hoshizaki | KM-1340MRJ | Ice Machine, 30", 1300lb | | x | 208 | 1 14 | 84" | Provide Shutoff @ Unit, Electric to Condenser @ Rooftop | FILTER | | 1" | | | | Requires #1013 Backflow Preventor, Inlet from Filter, PVC to Floor Trough |
| 503 1 Hoshizaki | URC-14F | Remote Condenser Unit | | X | 115 | 1 3 | | Electric from Ice Machine @ Rooftop, Provide Shutoff @ L | Unit | | | | | | |
| 504 1 Hoshizaki 505 1 T&S Brass | H9320-53 B-0665-BSTP | Water Filter System, Triple Service Sink Faucet | | | | | | | | 105" 33" 1/2 | " 33" | | | | Outlet to Ice Machine |
| 506 1 Advance Tabco | K-245 | Wall Shelf w/ Mop Rack | Mount @ 66" to Shelf | | | | | | | | | All - | | | |
| X 508 1 By Vendor | 9-OP-24FM-SSRL TBD | Mop Sink Water Softener Conditioner | | X 5-15F | P 115 1 | 1 8 | 60" | | 1/2" | 60" | 1" | 4" -1 | L4 | | PVC to Mop Sink, Outlet to HOT WATER ONLY |
| 509 2 Rinnai | C199IN | Tankless Water Heater, Gas | Con Minimum Co. Co. Co. Co. Co. | X 5-15F | | 1 3 | 72" | | 1/2" | | | | 3/4" | 83" 199k | NAT Engineer to Confirm Spec |
| X 510 1 Thunder Group X 511 2 By Vendor | CMSV_ CO2TANKS | Dry Storage Shelving CO2 Cylinder Tank | See Written Specs for Configuration | | | | | | | | | | | | |
| X 512 1 Lancer | 82-1792-601 | Bag in Box Syrup Tank Rack | | V 5 455 | 0 445 | 1 2 | 0.4" | | 4 /0" | 60" | | | | | Dodrfford Duorentee #4042 D |
| X 513 1 Lancer 514 1 AmeriKooler | 85-1923-00 1COMPBOX | Carbonator, Wall Mount Walk in Cooler | | X 5-15F | P 115 3 115 3 | 1 8 1 6 | | Light Connection for 2 Fixtures @ Box | 1/2" | טט" | | | | | Backflow Preventor #1013 Required |
| 515 1 AmeriKooler | BEL0155AS6AMAB0200 | Evaporator | | X | 115 | 1 2.7 | 120" | Provide Shutoff @ Unit Inside Cooler | | | | | | | |
| 516 1 AmeriKooler 517 1 Custom | BCH0015MBACZA0000 GLYCOLCHILLER | Remote Condenser Unit Draft Beer System Power Pack | Located on Top of Walk In Cooler | X X 5-20F | 208 1 P 115 1 | 1 15 1 15.7 | | Provide Shutoff @ Unit | | | | | | | |
| 518 1 Thunder Group | CMEP_ | Walk In Shelving | See Written Specs for Configuration | | | | | | | | | | | | |

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<u>LEGEND - PLUMBING CONNECTIONS</u>

UNTREATED COLD WATER STUB OUT

REVERSE OSMOSIS COLD WATER STUB OUT

SOFTENED HOT WATER STUB OUT

HOT/COLD WATER CONNECTION POINT TO BE INSTALLED BY PLUMBING CONTRACTOR

G-GAS STUB OUT AT WALL

GAS CONNECTION POINT
TO BE INSTALLED BY PLUMBING CONTRACTOR

DIRECT DRAIN STUB OUT

DRAIN CONNECTION POINT PVC OR COPPER (AS REQUIRED) TO FLOOR SINK TO BE INSTALLED BY PLUMBING CONTRACTOR

FLOOR SINK, NEW

FLOOR SINK, EXISTING

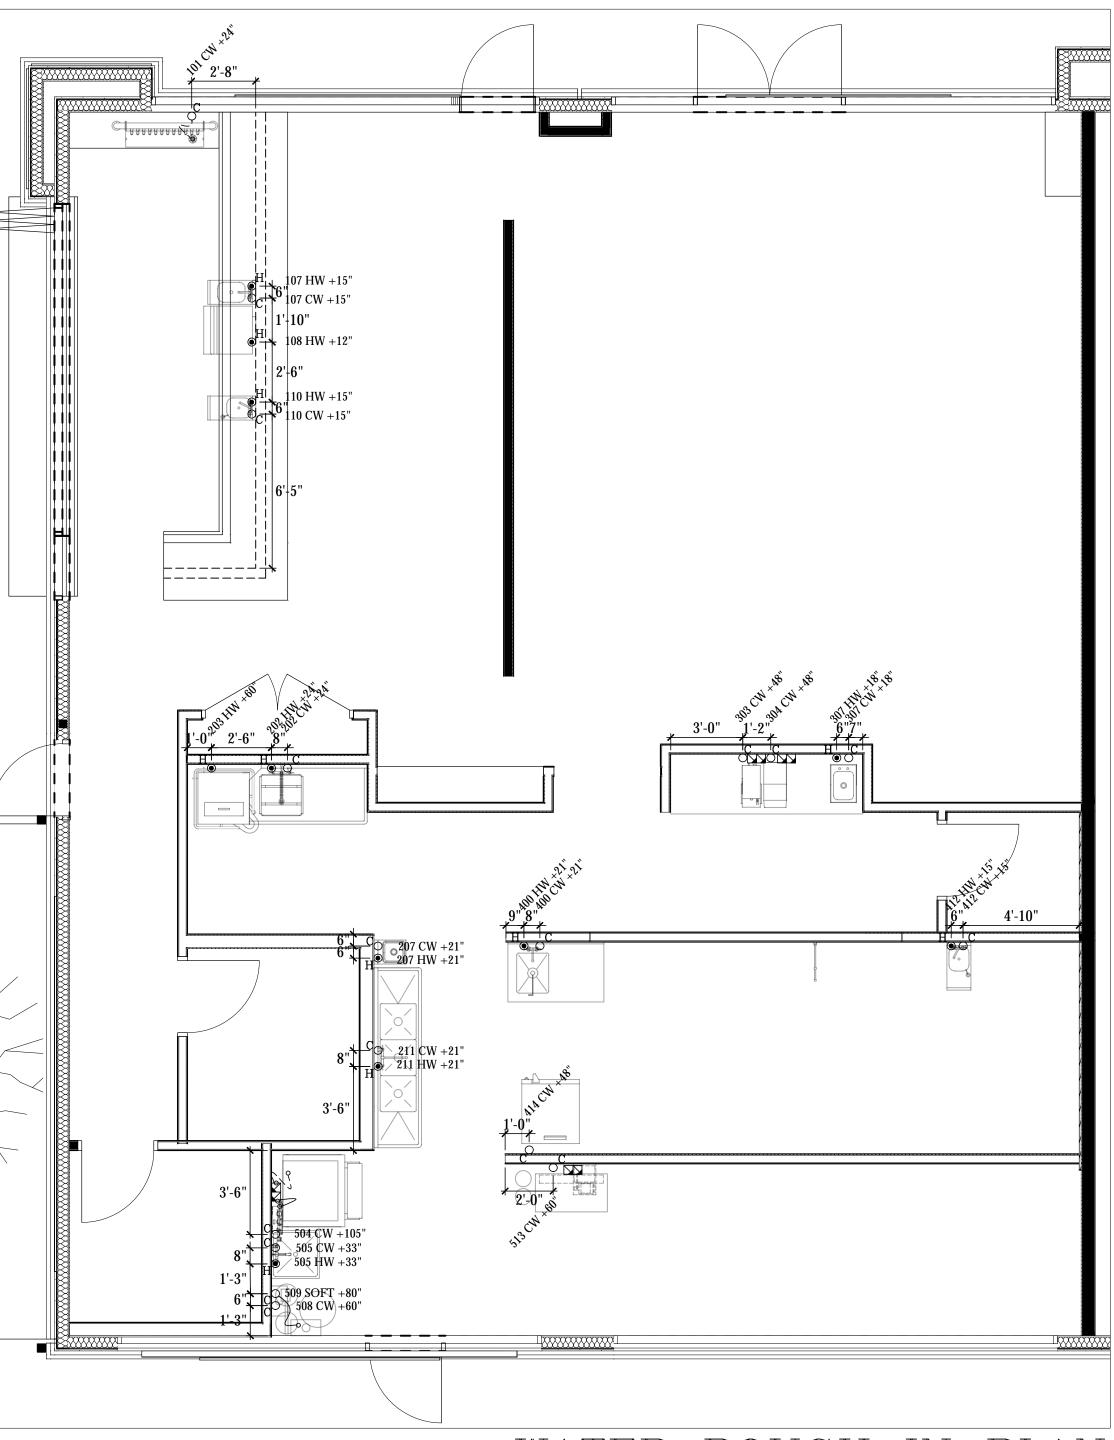
FLOOR DRAIN

BACKFLOW PREVENTER LOCATION

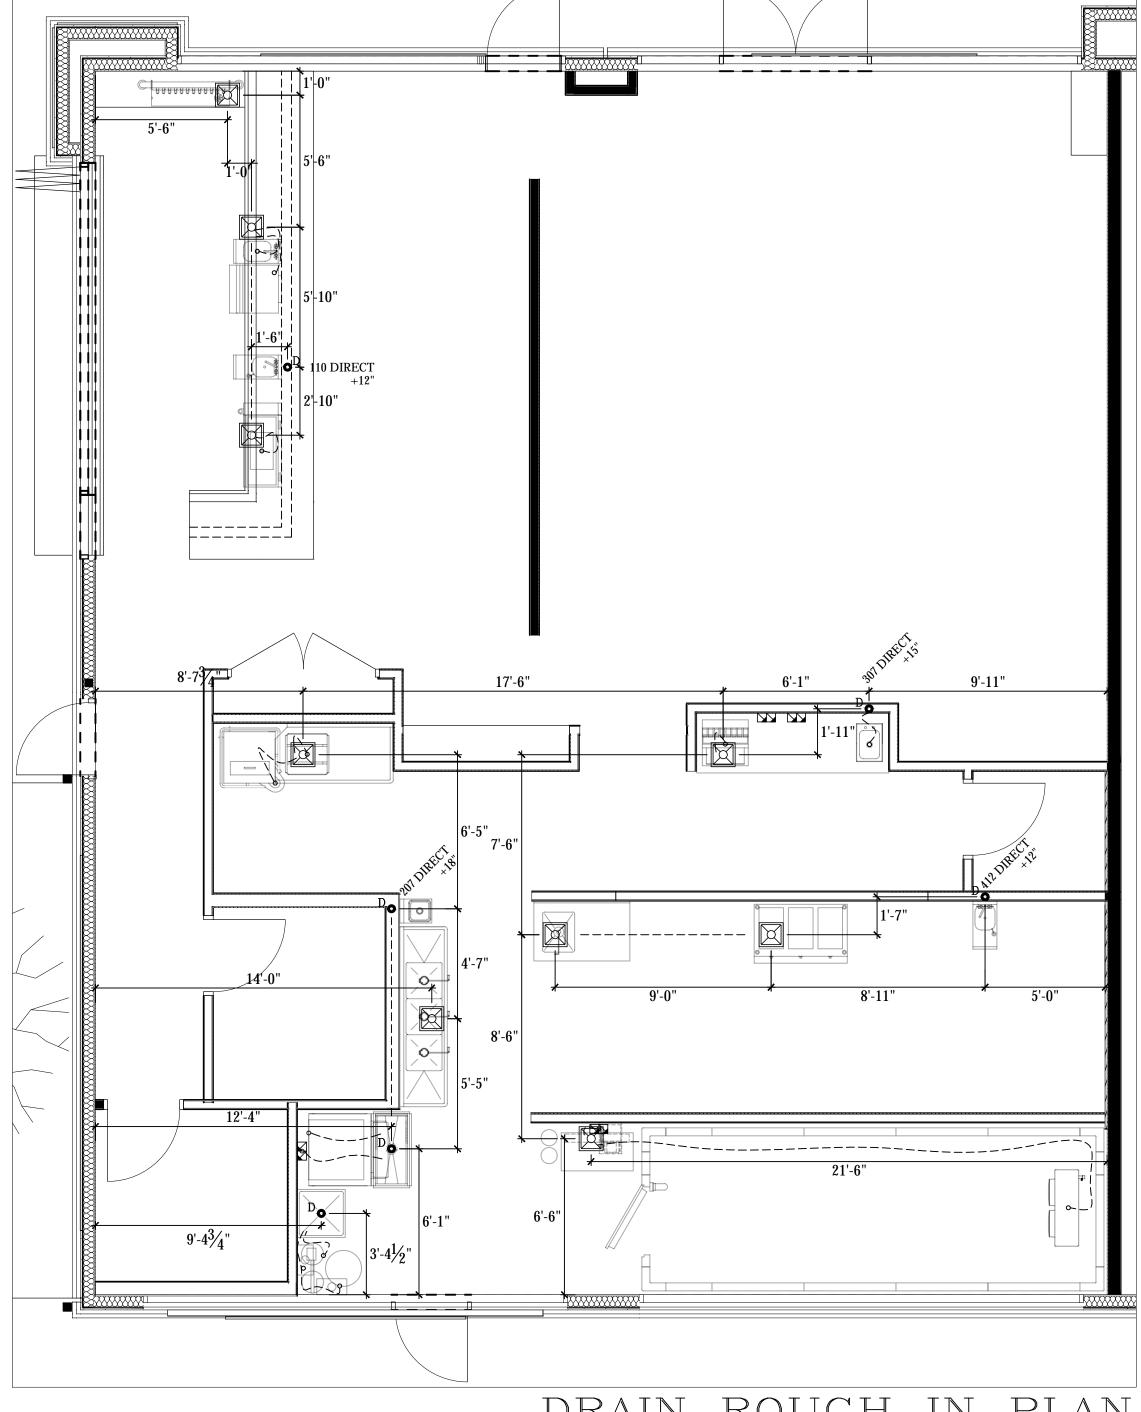
SODA CONDUIT STUB OUT (UNDERGROUND)

SODA LINES (OVERHEAD)

BEER CONDUIT STUB OUT (UNDERGROUND)



WATER ROUGH IN PLAN SCALE: 1/4"=1'-0"



DRAIN ROUGH IN PLAN SCALE: 1/4"=1'-0"

PLUMBING SCOPE OF WORK - WATER

KEC TO PROVIDE:

ALL FAUCETS, AS REFLECTED ON EQUIPMENT SCHEDULE,

WATER CONNECTION FROM ICE MACHINE FILTER TO ICE MACHINE.

PLUMBING CONTRACTOR TO PROVIDE:

- INSTALLATION OF ALL FIXTURES PROVIDED BY KEC,
- FINAL WATER CONNECTIONS FOR ALL EQUIPMENT REQUIRED, CONNECTION FROM STUB OUT TO ANY WATER FILTER,
- ½" SHUT OFF VALVE FROM STUB OUT TO ALL WATER FILTERS REFLECTED ON THIS PLAN, NECESSARY BACK FLOW EQUIPMENT AT SODA EQUIPMENT, ICE MACHINE, OR ANY OTHER
- DIRECT WATER CONNECTION AS REQUIRED PER CODE,
- PRESSURE REGULATOR FOR PROPER INSTALLATION OF DISH MACHINE AS REQUIRED BY MANUFACTURER.

VENDOR TRADES:

- FINAL CONNECTION FROM FILTER TO PROVIDED EQUIPMENT.

PLUMBING SCOPE OF WORK - DRAINS

KEC TO PROVIDE:

ALL TWIST WASTE VALVES & BASKET DRAINS, AS REFLECTED ON EQUIPMENT SCHEDULE,

- INSTALLATION OF PVC DRAINS FOR ICE MACHINE AND ICE BIN WITH NECESSARY AIR VENT AS PER CODE, PIPE CONDENSATE DRAIN FOR WALK IN COOLER WITH 3/4" COPPER TUBING, WITH NECESSARY "P" TRAPS AS PER CODE,
- PIPE CONDENSATE DRAIN FOR WALK IN FREEZER WITH 3/4" COPPER TUBING, WITH NECESSARY "P" TRAPS AS PER CODE, PROVIDE INSULATION AND HEAT TAPE IN ALL FREEZER AREAS.

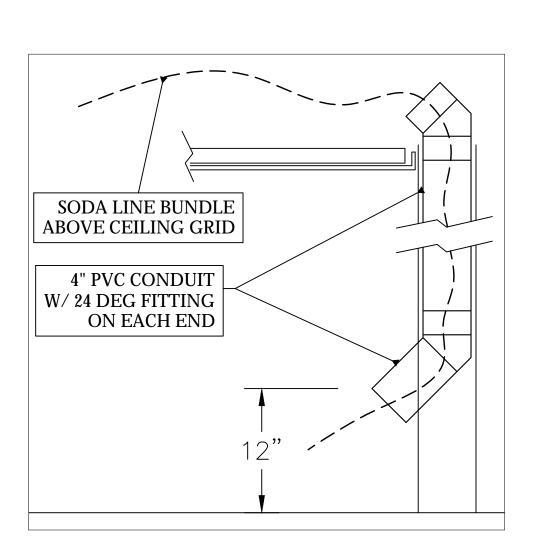
PLUMBING CONTRACTOR TO PROVIDE:

- RIGID DRAIN LINES FOR ALL DIRECT & INDIRECT WASTE. COPPER REQUIRED FOR HOT WATER DRAIN APPLICATIONS/PVC FOR COLD, SEE PLUMBING SCHEDULE NOTES,
- MINIMIUM 1 ½" AIR GAP ABOVE FLOOR SINK FOR ALL INDIRECT WASTE PER CODE, ANCHOR ALL INDIRECT PIPING MINIMUM 6" ABOVE FLOOR WITH UNI-STRUT AND STRAPS FOR CLEAN FINISH.

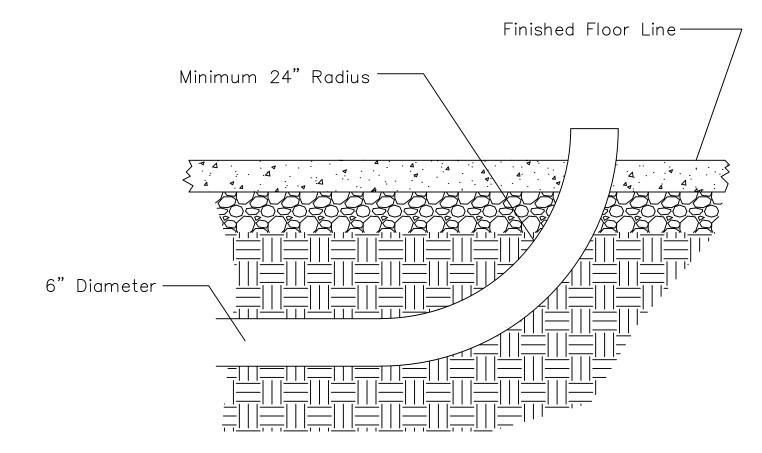
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PLUMBIN



Underground Conduit Specification



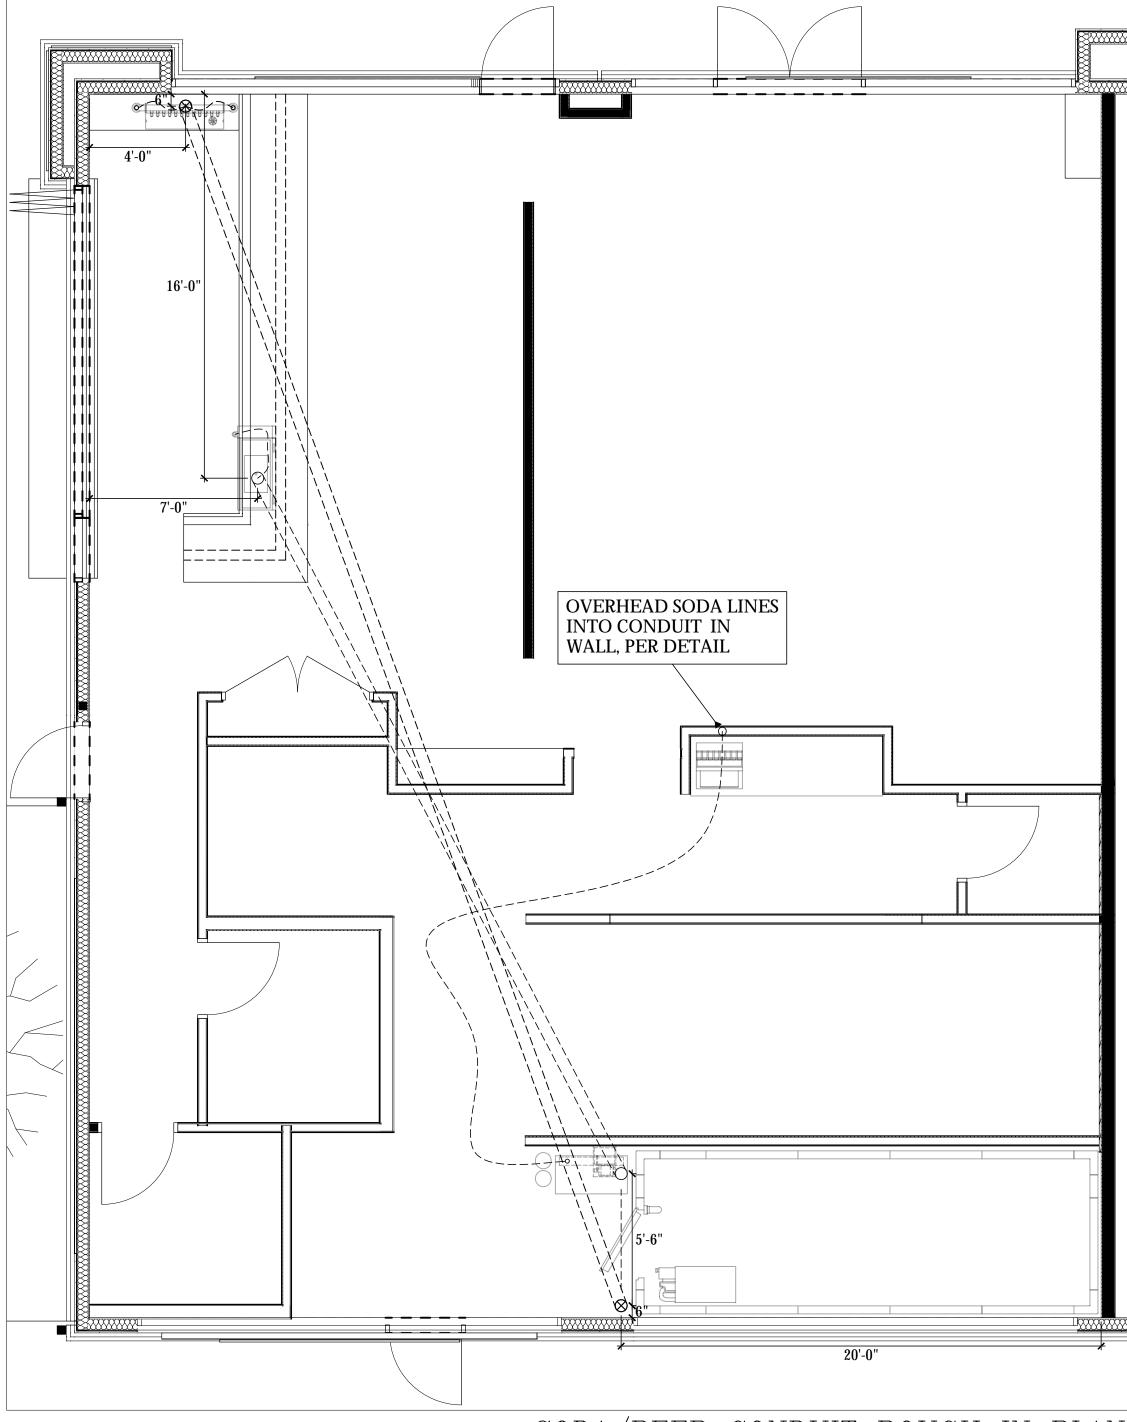
<u>LEGEND - PLUMBING CONNECTIONS</u>

- UNTREATED COLD WATER STUB OUT
- REVERSE OSMOSIS COLD WATER STUB OUT
- SOFTENED HOT WATER STUB OUT
- HOT/COLD WATER CONNECTION POINT TO BE INSTALLED BY PLUMBING CONTRACTOR
- G-GAS STUB OUT AT WALL
- GAS CONNECTION POINT
 TO BE INSTALLED BY PLUMBING CONTRACTOR
- DIRECT DRAIN STUB OUT
- PVC OR COPPER (AS REQUIRED) TO FLOOR SINK TO BE INSTALLED BY PLUMBING CONTRACTOR

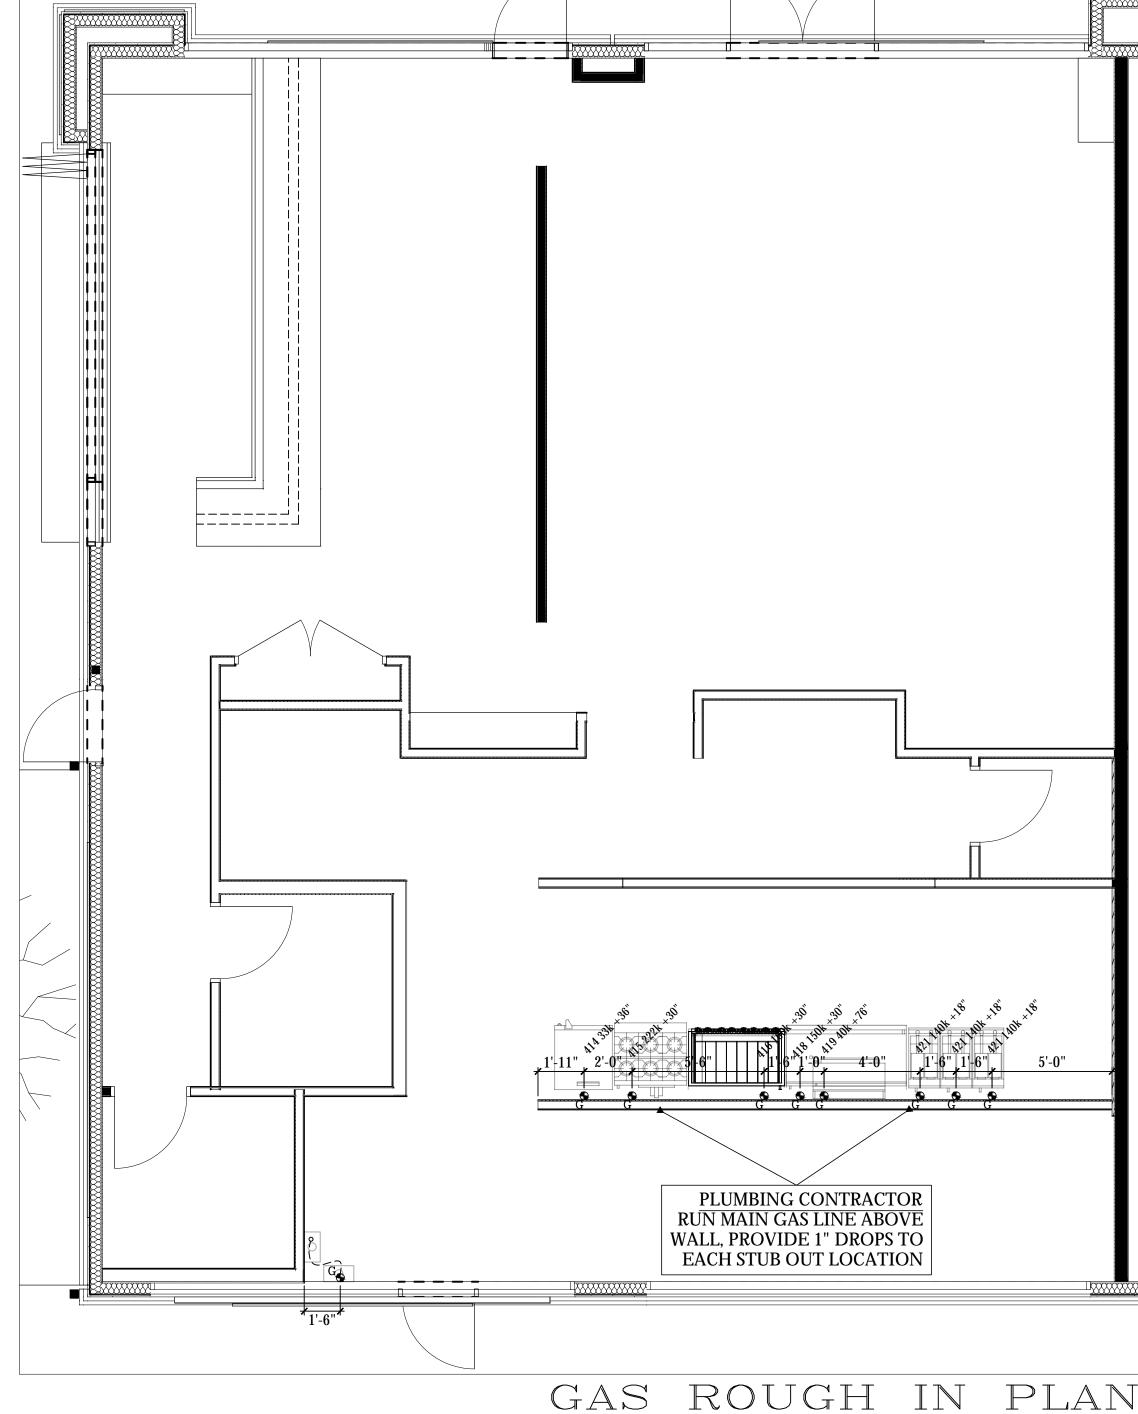
FLOOR SINK, NEW

FLOOR SINK, EXISTING

- FLOOR DRAIN
- BACKFLOW PREVENTER LOCATION
- SODA CONDUIT STUB OUT (UNDERGROUND)
- SODA LINES (OVERHEAD)
- BEER CONDUIT STUB OUT (UNDERGROUND)







PLUMBING SCOPE OF WORK - SODA/BEER

KEC TO PROVIDE:

- NECESSARY DRAFT BEER EQUIIPMENT PER SPEC. INSTALLATION OF ALL PROVIDED BEER EQUIPMENT,
- PLUMBING CONTRACTOR TO PROVIDE:
- 6-8" PVC UNDERGROUND CONDUIT WITH MINIMUM 24" RADIUS SWEEP AS REFLECTED ON THE DETAIL ABOVE,
- NECESSARY BACK FLOW EQUIPMENT AT SODA EQUIPMENT AS PER CODE. DRAIN LINES AS REQUIRED.

ELECTRICAL CONTRACTOR TO PROVIDE:

- INSTALLATION OF CO2 ALARM FOR BULK CO2 APPLICATIONS AS PER CODE REQUIREMENTS.

VENDOR TRADES:

- ALL NECESSARY SODA EQUIPMENT FOR OPERATION OF SYSTEM,
- INSTALLATION OF SODA LINES IN PROVIDED UNDERGROUND CONDUIT OR OVERHEAD ABOVE CEILING, AS REFLECTED ABOVE,
- TRIM REMAINING CONDUIT TO NO MORE THAN 4" ABOVE FLOOR PRIOR TO FOAMING AND FINAL SEAL AT ALL OPENINGS UPON COMPLETION OF INSTALLATION, PROPER UNDERBAR SECURING OF SODA GUNS AND CINCHING OF ALL LOOSE SODA LINES FOR CLEANEST POSSIBLE
- CO2 ALARMS AS NECESSARY PER CODE REQUIREMENTS.

PLUMBING SCOPE OF WORK - GAS NOTES

KEC TO PROVIDE:

- QUICK DISCONNECT GAS HOSE KITS, ¾" X 48" FOR EACH PIECE OF GAS EQUIPMENT AS NOTED ON EQUIPMENT SCHEDULE,
- SOLENOID VALVE FOR MAIN GAS LINE SHUT OFF (PART OF THE ANSUL SYSTEM).

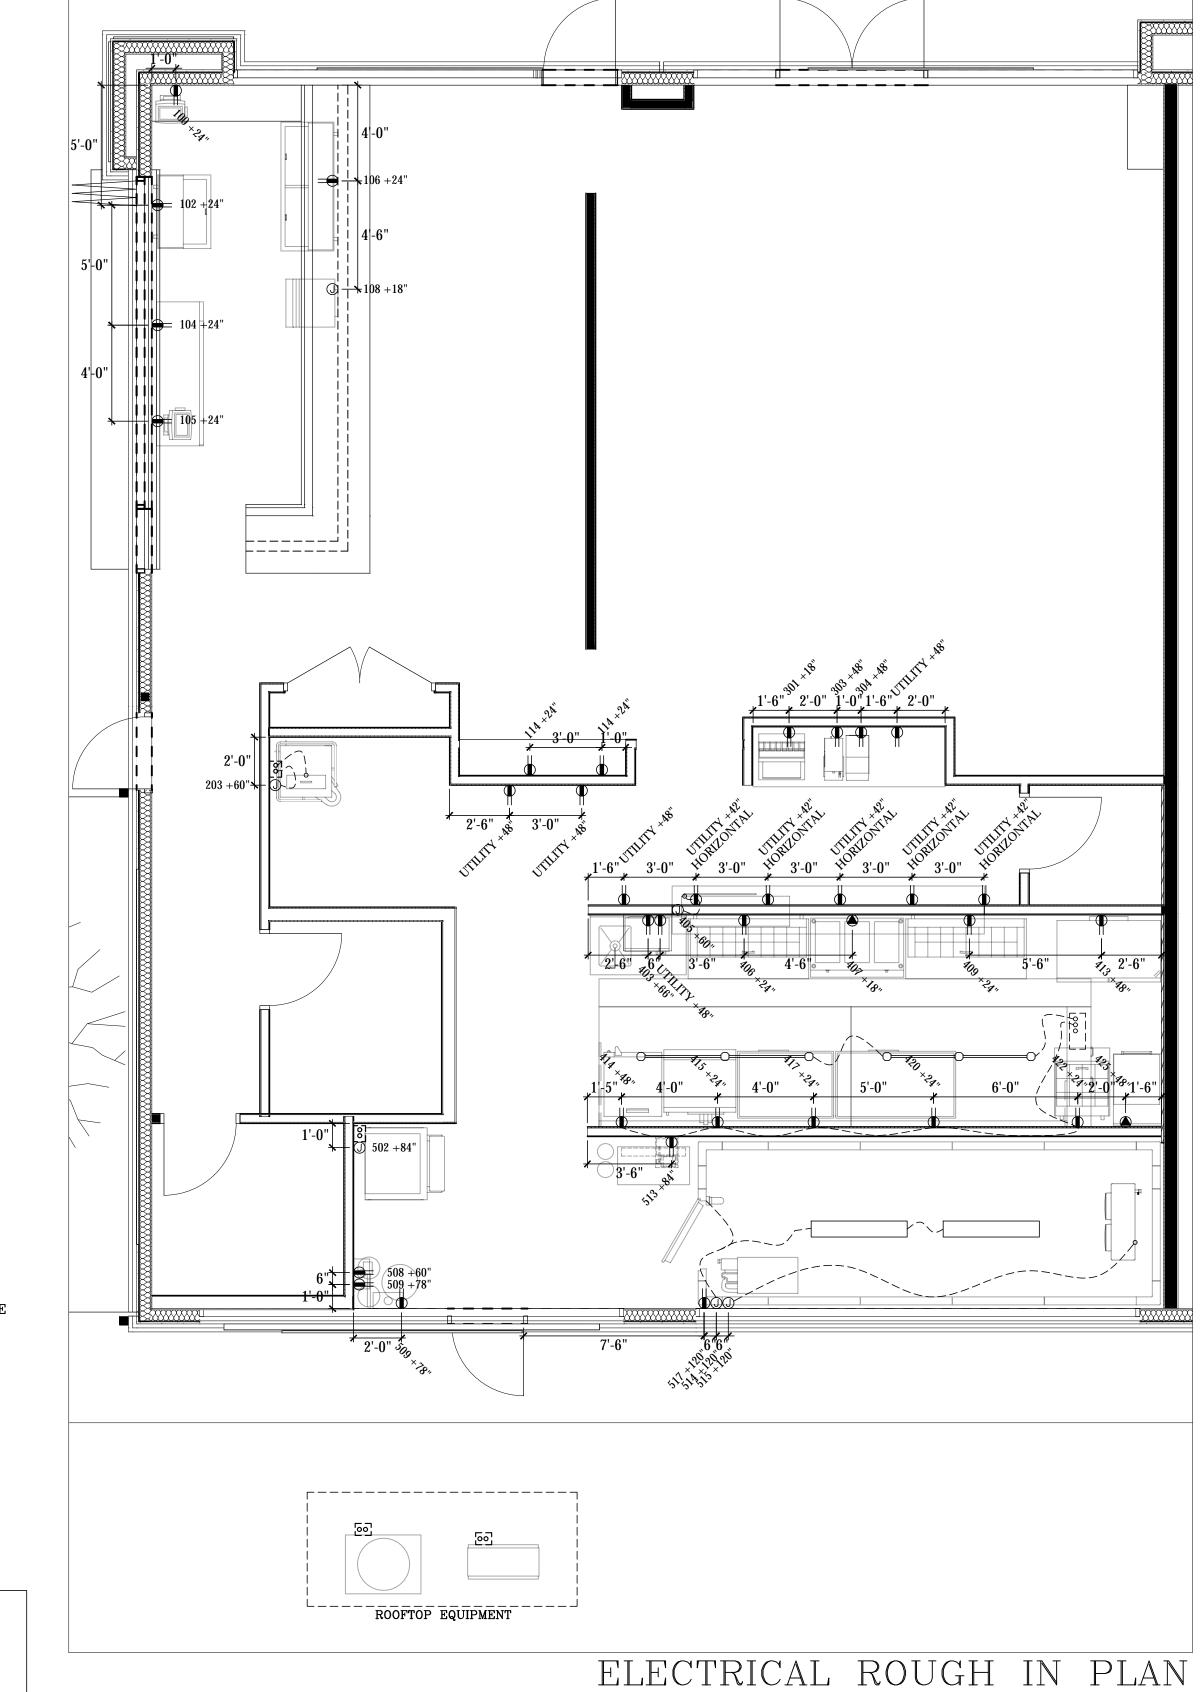
PLUMBING CONTRACTOR TO PROVIDE:

- INSTALLATION OF ALL QUICK DISCONNECT GAS HOSES & SAFETY CABLES AS SHOW IN THE DETAIL ABOVE,
- INSTALLATION OF SOLENOID VALVE FOR MAIN GAS LINE IN LOCATION DETAILED BY PLUMBING ENGINEER ON GAS LINE SCHEMATIC. APPROPRIATE GAS PSI/W.C. TO ALL NECESSARY EQUIPMENT, PER SPEC SHEETS PROVIDED
- ELECTRICAL CONTRACTOR TO PROVIDE:

WIRING FROM SOLENOID VALVE TO ELECTRICAL CONTROLS OF HOOD SYSTEM.

SCALE: 1/4"=1'-0" PLUMBIN Drawn by: JBM Checked by: 3/1/2022 Sheet Number:

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SCALE: 1/4"=1'-0"

<u>LEGEND - ELECTRICAL CONNECTIONS</u>

DUPLEX RECEPT., 15-AMP, 120-VOLT, GROUND TYPE, VERTICAL MOUNT

DUPLEX RECEPT., 20-AMP, 120-VOLT, GROUND TYPE, VERTICAL MOUNT DUPLEX RECEPT. W/ GFI, 20-AMP, 120-VOLT, GROUND TYPE, VERTICAL MOUNT

SIMPLEX RECEPT., 20-AMP, 120-VOLT, GROUND TYPE, VERTICAL MOUNT

> SPECIAL PURPOSE OUTLET, 208/240-VOLT NEMA CONFIG. AS INDICATED, ON EQUIP. SCHEDULE AS INDICATED, GROUND TYPE, VERTICAL MOUNT

JUNCTION BOX FOR DIRECT CONNECTION

STUB OUT FOR UNDERGROUND CONDUIT

FIELD WIRING, EXPOSED RIGID WATERTIGHT CONDUIT

REMOTE CONDENSER ELECTRICAL CONNECTION OUTGOING FROM KITCHEN TO ROOFTOP

MANUAL DISCONNECT SWITCH, WATERTIGHT

ELECTRICAL SCOPE OF WORK

ELECTRICAL CONTRACTOR NOTES:

1) ALL DIMENSIONS ARE TO CENTER OF OUTLET BOX.

2) RUN CONDENSER POWER FROM BACK OF ICE MACHINE TO ROOFTOP WITH REFRIGERATION LINES,

3) MOUNT WATERPROOF JBOX TO ICE MACHINE CONDENSER - PROVIDE SHUT OFF SWITCH WITHIN 6 FEET PER CODE - INCOMING POWER FROM ICE MACHINE TO ROOFTOP LOCATION,

4) PROVIDE DIRECT SHUNT TRIP BREAKER FOR WALK IN FREEZER DOOR HEAT STRIP (BY KEC/WALK IN MANUFACTURER) AND DRAIN LINE HEATER (BY KEC) - WIRE TIME CLOCK IF SHIPPED LOOSE,

5) PROVIDE DISCONNECT SWITCH FOR EACH WALK IN CONDENSER WITHIN 6 FEET PER

6) WIRE EXHAUST FANS, MAKE UP AIR UNITS AND ALL DESIGNATED OUTLETS UNDER HOOD SYSTEMS INTO ELECTRICAL CONTROL PANEL (KEC PROVIDED).

GENERAL NOTES:

PROVIDE GFI OUTLETS IN ALL AREAS OF THE KITCHEN,

DIRECT CONNECTIONS REQUIRED ARE TO BE WATERTIGHT CONDUIT

Checked by:

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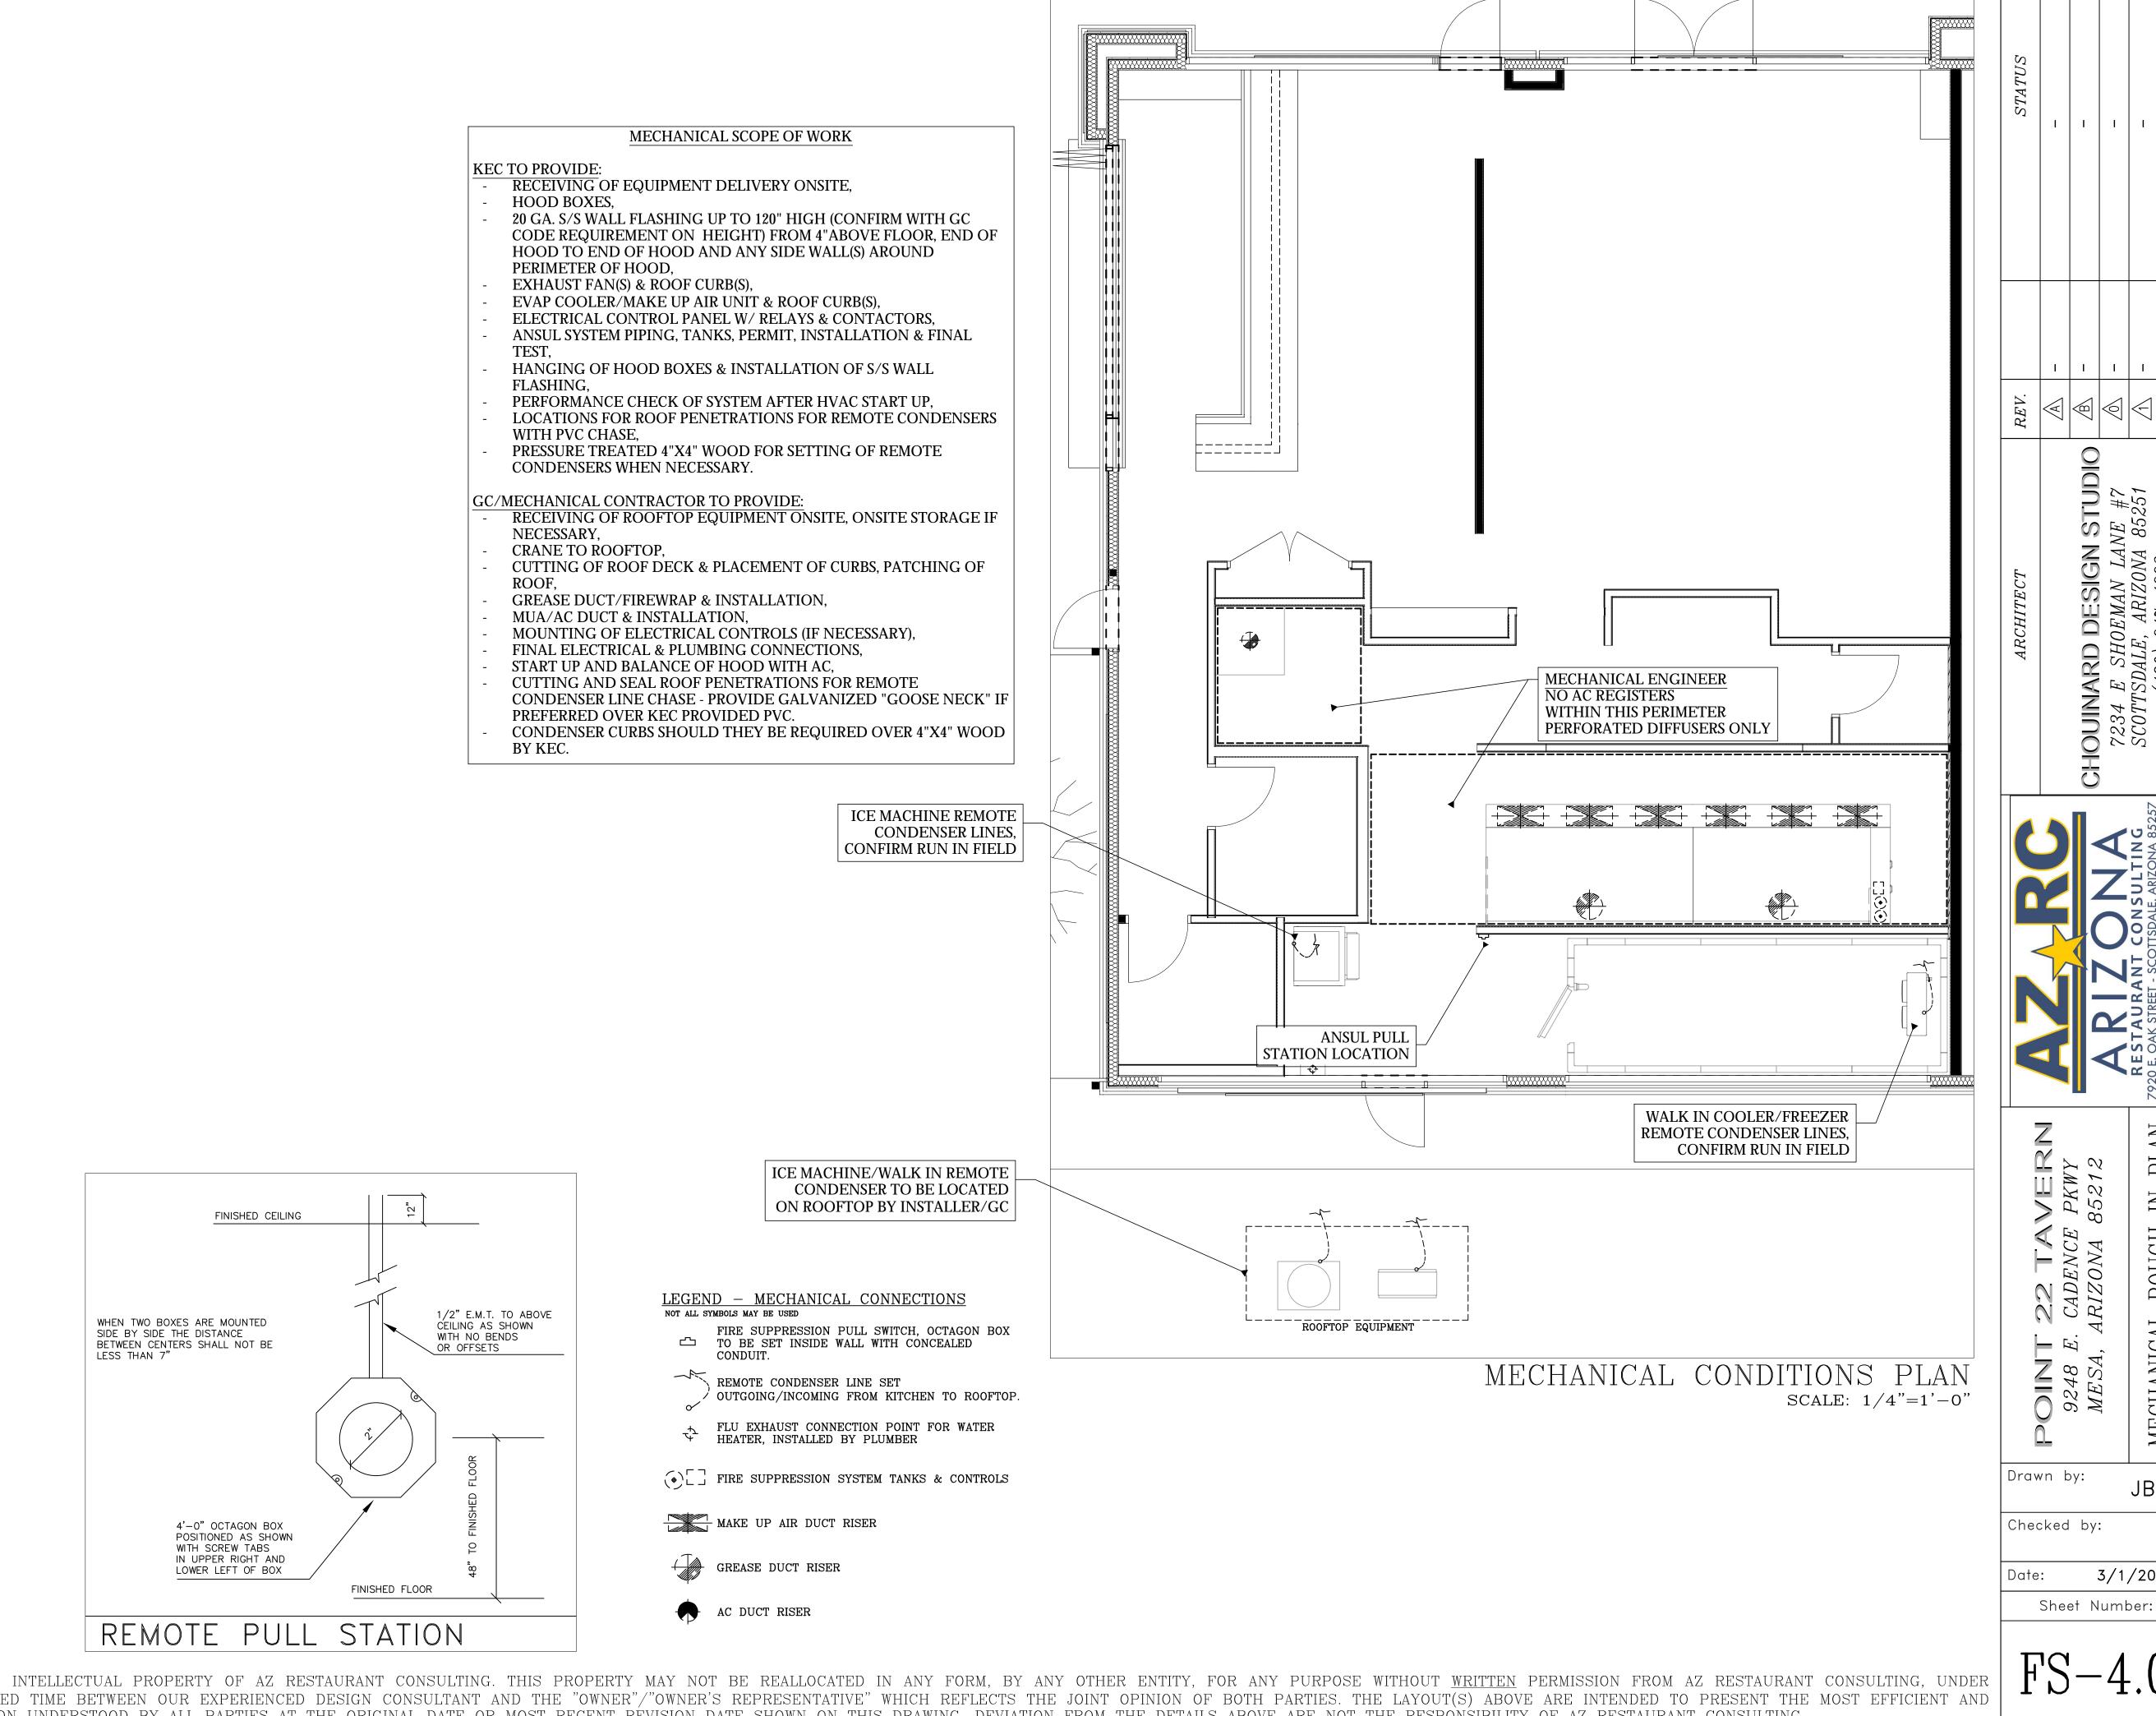
Sheet Number:

3/1/2022

ELECTRIC/

CHOUINARD DESIGN STUDIO
7234 E SHOEMAN LANE #7
SCOTTSDALE, ARIZONA 85251
(480) 947-4992

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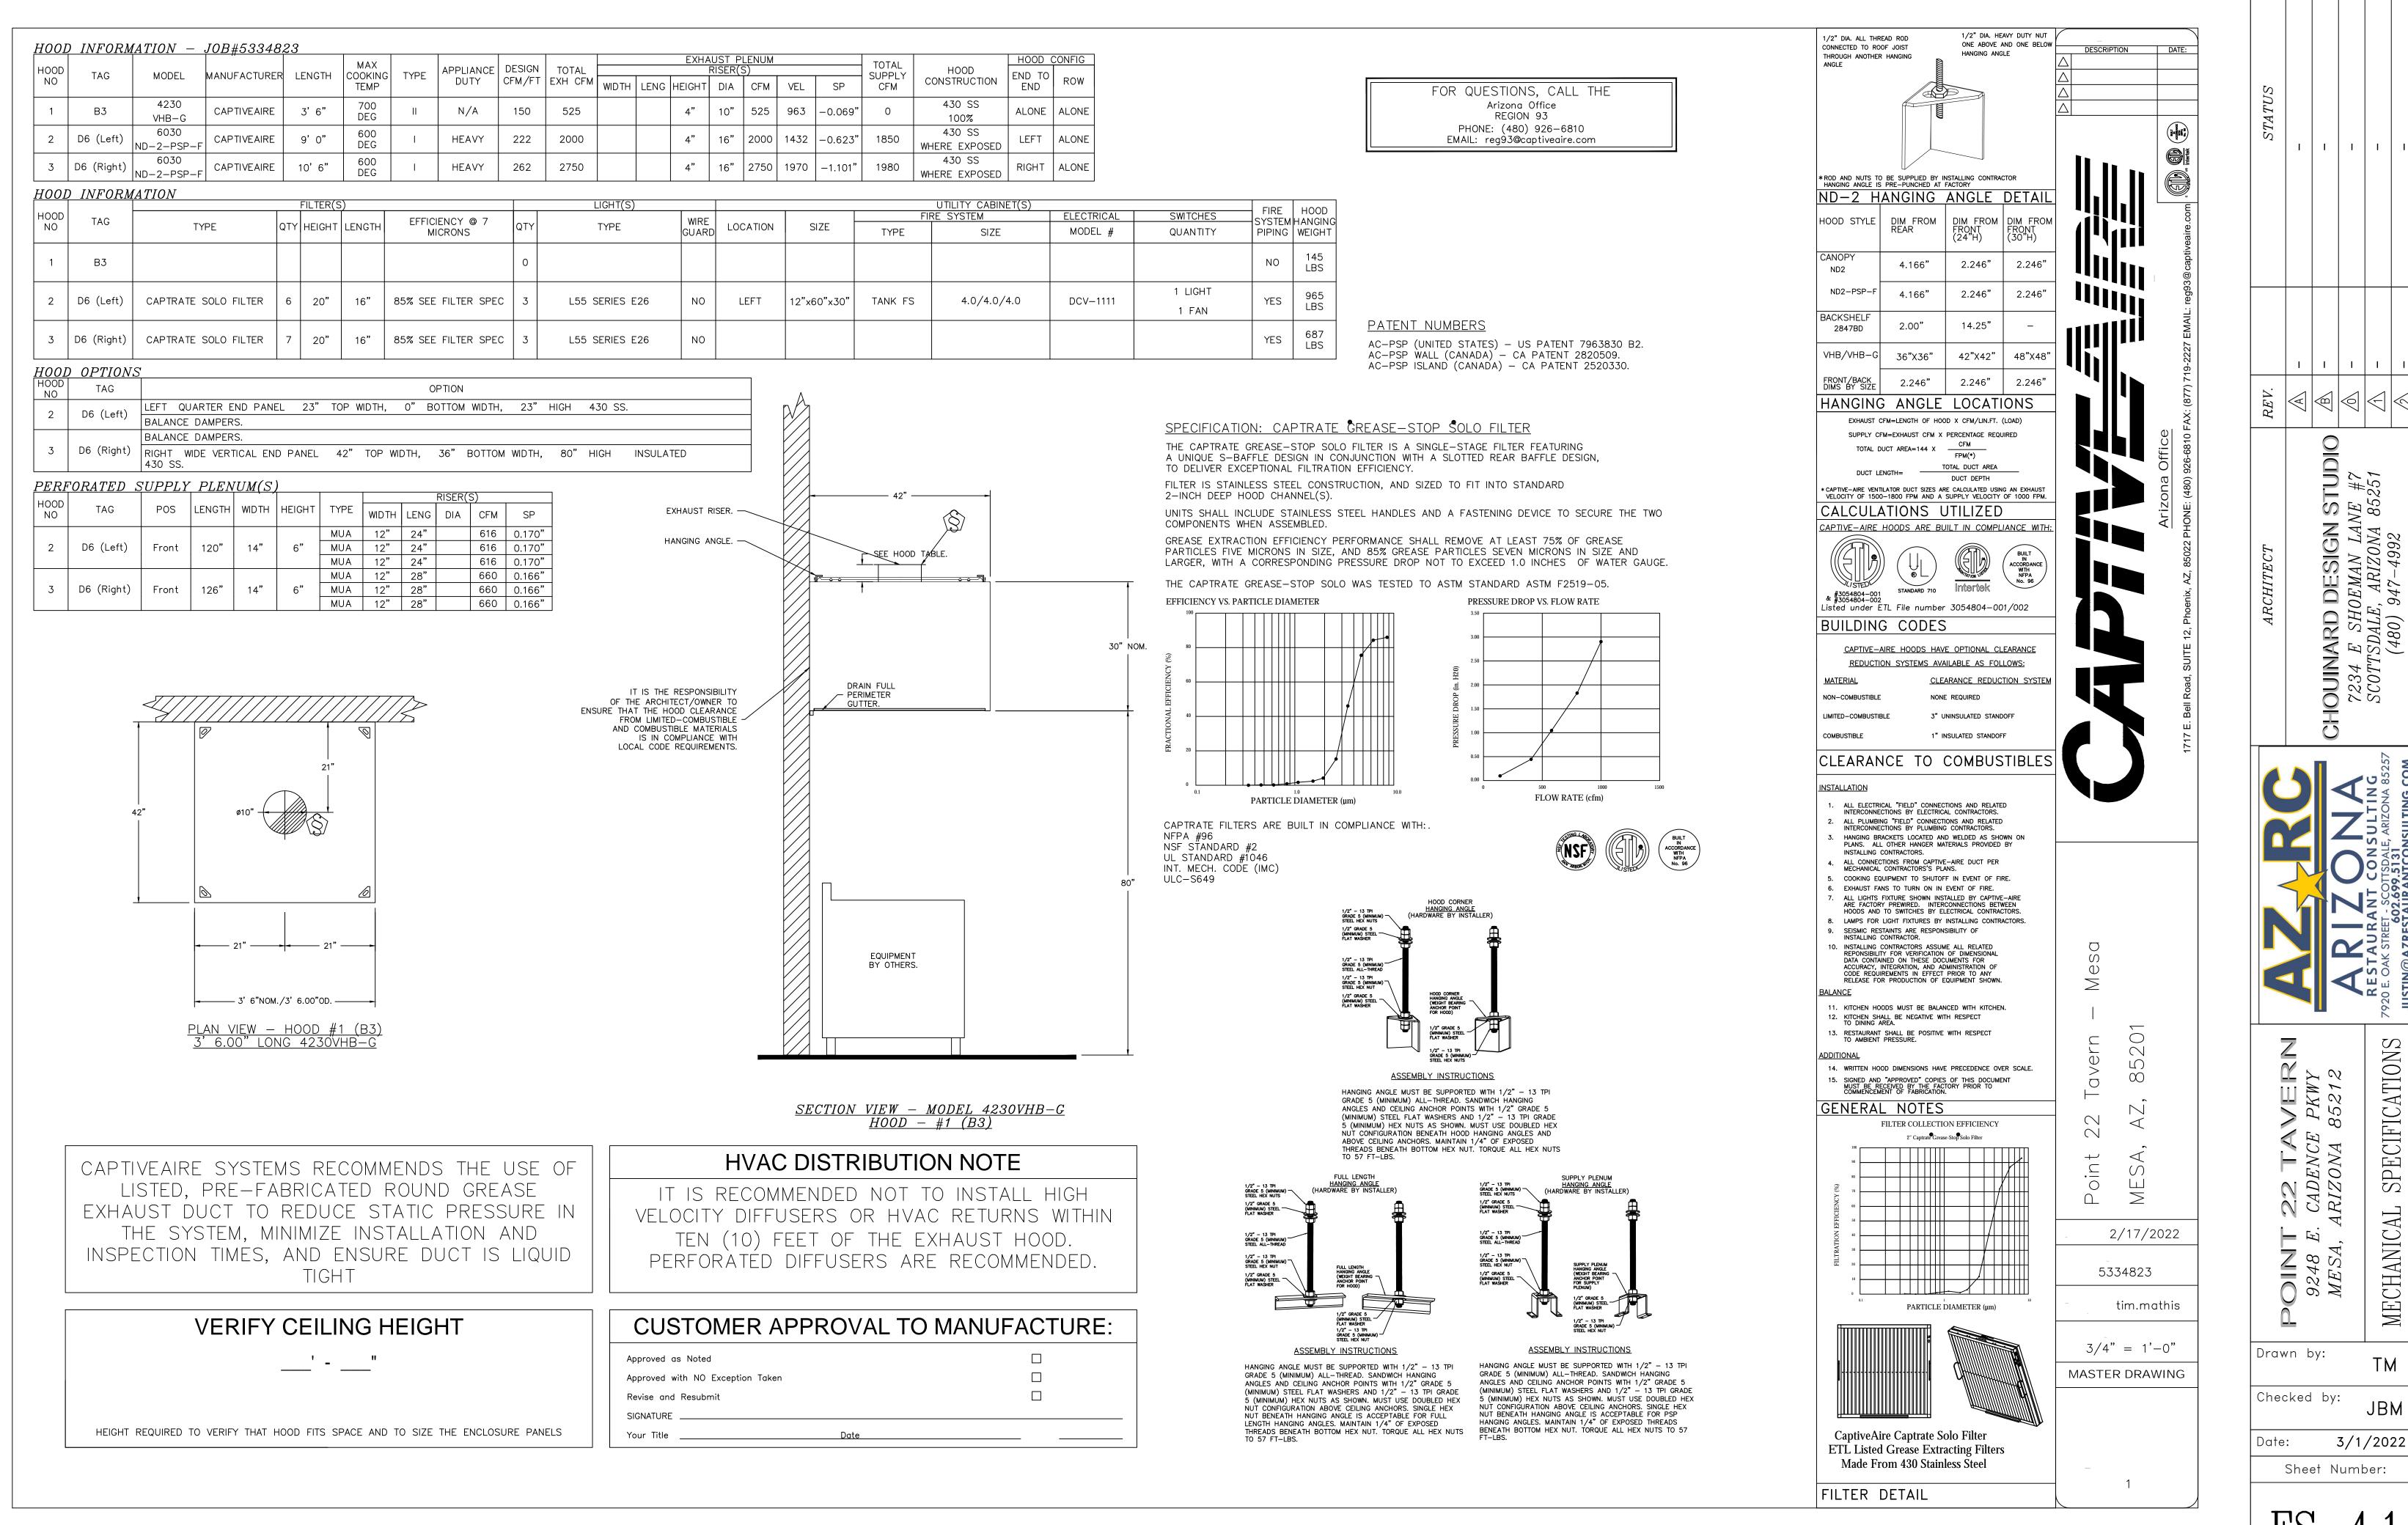


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ROUGH

MECHANICAL

3/1/2022

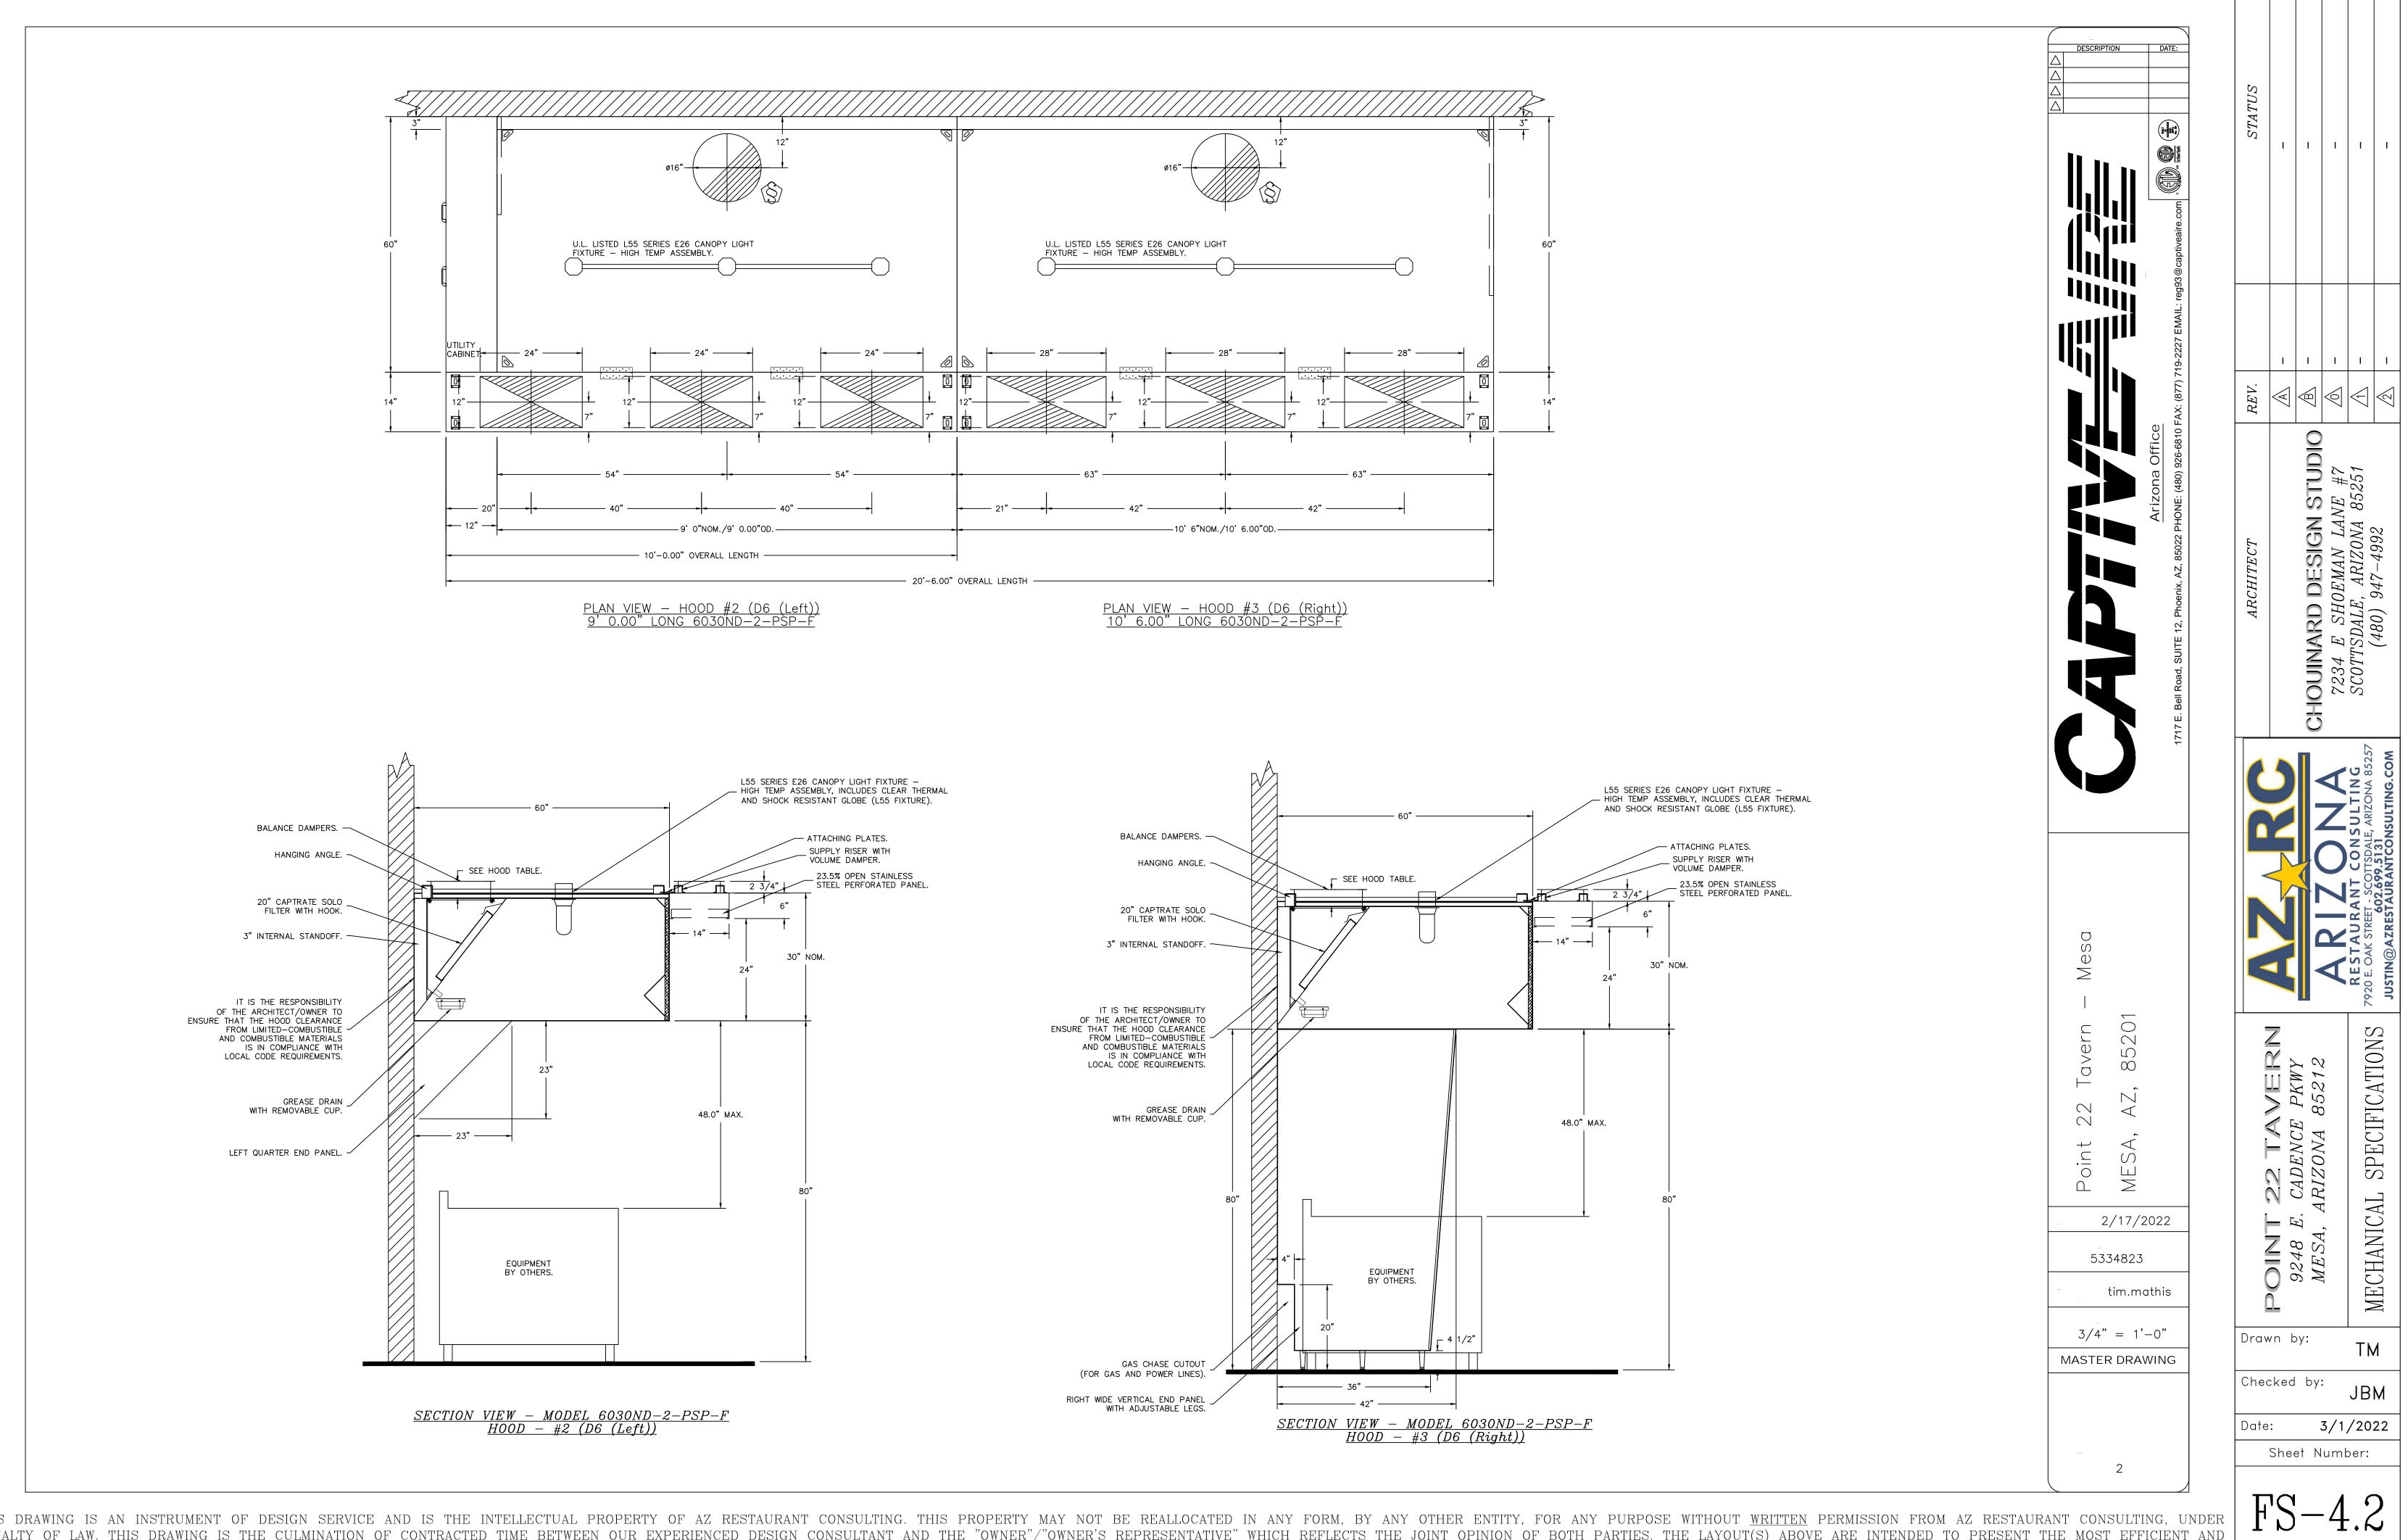


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JBM 3/1/2022

SPECIFICATION

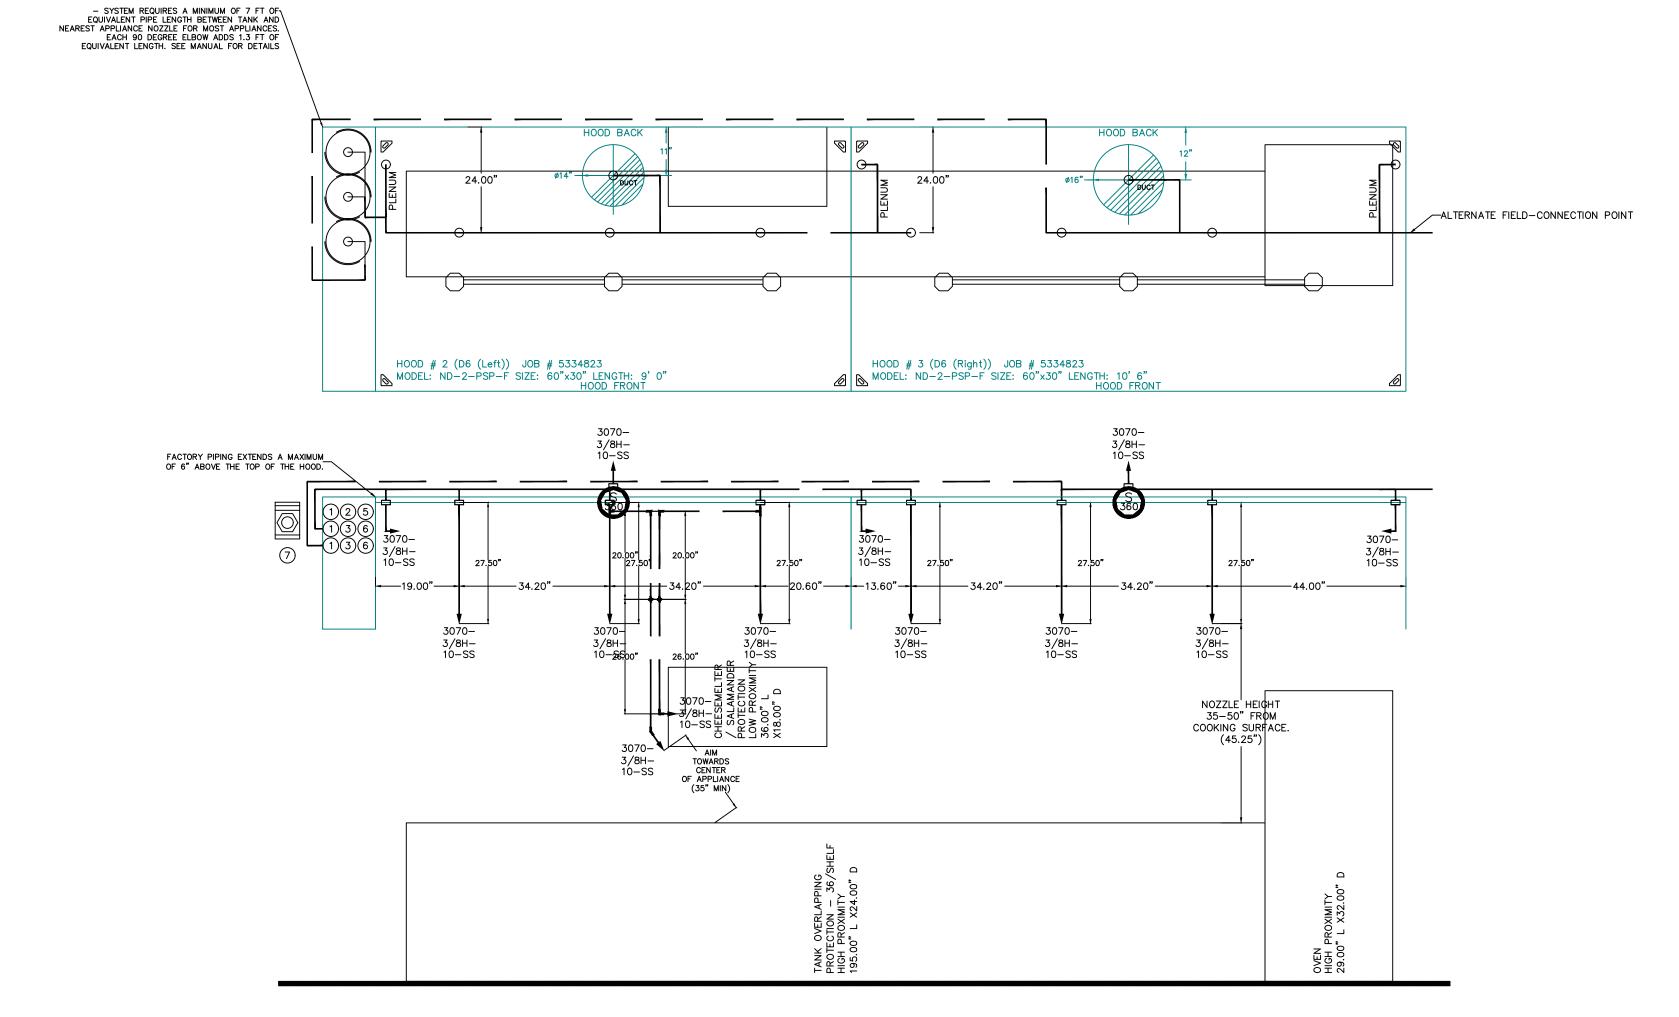
MECHANICAL



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| FIRE | SYST | EM INFORMATIO | ON - JOB#5334823 | | | | | | |
|--------------|------|---------------|------------------|--------|-------------------|------------------|--|--|--|
| FIRE | | | ,, | FLOW | INSTALLA | TION | | | |
| SYSTEM NO | TAG | TYPE | SIZE | POINTS | SYSTEM | LOCATION ON HOOD | | | |
| 1 | | TANK FS | 4.0/4.0/4.0 | 58 | FIRE CABINET LEFT | LEFT, HOOD 2 | | | |
| | | | | | | | | | |

| GAS VAI | VE(S |) | | |
|----------------------|------|---------------|------|---------------------|
| FIRE SYSTEM NO | TAG | TYPE | SIZE | SUPPLIED BY |
| 1 | | SC ELECTRICAL | TBD | CAPTIVEAIRE SYSTEMS |



NOTES
- FIELD PIPE DROPS AS SHOWN
PIPING, ELBOWS, TEES, AND NOZZLES SUPPLIED BY CAS.
- RELOCATE NOZZLES IF FLOW PATTERN IS BLOCKED BY SHELVING,
SALAMANDERS, ETC.
- OVERLAPPING COVERAGE SHALL NOT BE USED ON ANY APPLIANCE WITH AN OBSTRUCTION.
- IF APPLICABLE, EXTENDED PRE-PIPED DROPS ARE SHIPPED LOOSE.
- FACTORY PIPING EXTENDS A MAXIMUM OF 6" ABOVE THE TOP OF THE HOOD.

- APPLIANCE DIMENSIONS LISTED REPRESENT THE COOKING SURFACE
SIZE, NOT THE OVERALL APPLIANCE SIZE.
- THIS FIRE SYSTEM COMPLIES WITH U.L. 300 REQUIREMENTS.

JOB #: 5334823.
JOB NAME: POINT 22 TAVERN - MESA.

SYSTEM SIZE: TANK-SP-3 TOTAL FP REQUIRED: 58.
HOOD # 2 9" 0.00" LONG x 60" WIDE x 30" HIGH.
RISER # 1 SIZE: 14" DIA.
HOOD # 2 METAL BLOW-OFF CAPS INCLUDED.
HOOD # 3 10' 6.00" LONG x 60" WIDE x 30" HIGH.
RISER # 1 SIZE: 16" DIA.
HOOD # 3 METAL BLOW-OFF CAPS INCLUDED.

- HEAVY-DUTY APPLIANCES (RATED 600'F) WILL REQUIRE AN ADDITIONAL
DOWNSTREAM FIRESTAT IN THE EVENT THAT THE DUCTWORK CONTAINS ANY
HORIZONTAL RUNS OVER 25 FT IN LENGTH.
- MEDIUM TO LIGHT-DUTY APPLIANCES (RATED 450'F) WILL NOT REQUIRE ANY
ADDITIONAL DOWNSTREAM DETECTION.

<u>LEGEND - FIRE CABINET TANK SYSTEM</u>

PRIMARY ACTUATOR RELEASE. SECONDARY ACTUATOR RELEASE.

PRIMARY HOSE ASSEMBLY. SECONDARY HOSE ASSEMBLY.

PRESSURE SUPERVISION SWITCH.

REMOTE MANUAL ACTUATION DEVICE.

4 GALLON TANK.

Arizona Office

Arizona Office

Arizona Office

(A80) 926-6810 FAX: (877) 719-2227 EMAIL: reg93@captiveaire.com

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2/17/2022

tim.mathis

5334823

3/4" = 1'-0"

MASTER DRAWING

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A R I Z O N SULTING 920 E. OAK STREET - SCOTTSDALE, ARIZONA 85251 (480) 947-4992

INT 22 TAVERN 248 E. CADENCE PKWY ESA. ARIZONA 85212

SPECIFICATION

MECHANICAL

Drawn by:

Checked by:

te: 3/1/2022

Sheet Number:

EXHAUST FAN INFORMATION - JOB#5334823 WEIGHT MOTOR ENCL DISCHARGE FAN UNIT MODEL # MANUFACTURER ESP RPM HP | BHP | PHASE | VOLT CFM VELOCITY (LBS) 1 KEF-1 (B3) DU33HFA CAPTIVEAIRE 525 | 0.350 | 1156 | TEAO-ECM | 0.333 | 0.0920 | 1 | 115 | 4.3 260 FPM 67 9.4 2 KEF-2 (D6) CAPTIVEAIRE 4750 | 1.750 | 996 | ODP, PREMIUM | 5.000 | 2.7370 | 3 | 208 | 15.8 | 312 DU240HFA 1080 FPM

MUA FAN INFORMATION - JOB#5334823

| F/ UN N | AN NIT O | TAG | QTY | FAN UNIT MODEL # | BLOWER | HOUSING | MIN CFM | DESIGN CFM | ESP | RPM | MOTOR ENCL | НР ВНР | PHASE | VOLT | FLA MCA | MOCP | EVAP FLOW RATE (Gal/Hr) | EVAP COOLER ENTERING DB TEMP | EVAP COOLER ENTERING WB TEMP | EVAP COOLER LEAVING DB TEMP | EVAP COOLER LEAVING WB TEMP | WEIGHT (LBS) | SONES |
|---------------|----------------|-------|-----|------------------|------------|---------|------------|---------------|-------|------|---------------|--------------|-------|------|----------|------|-------------------------------|------------------------------------|------------------------------------|-----------------------------------|-----------------------------------|-----------------|-------|
| | 3 N | /AU-1 | 1 | A2-20D | 20MF-2-MOD | A2 | 1500 | 3830 | 0.500 | 1436 | ODP,PREMIUM | 3.000 1.6700 | 3 | 208 | 9.5 11.9 | 20A | 5.41 | 110.0°F | 70.0°F | 88.0°F | 70.0°F | 700 | 17.6 |

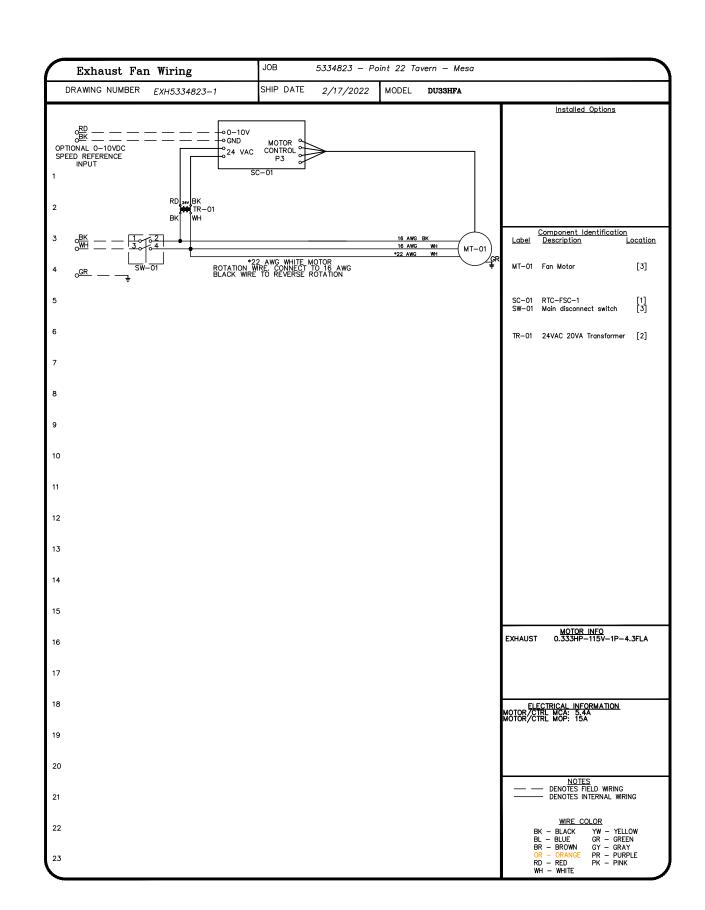
FAN OPTIONS

| UNIT | TAG | QTY | DESCRIPTION |
|------|------------|-----|--|
| | | 1 | I 15-BDD DAMPER |
| | | 1 | SCR-11 BIRD SCREEN |
| 1 | KEF-1 (B3) | 1 | ECM WIRING PACKAGE — MANUAL OR 0-10VDC REFERENCE SPEED CONTROL (TELCO MOTOR), CCW ROTATION |
| | | 1 | 2 YEAR PARTS WARRANTY |
| | KEF-2 (D6) | 1 | GREASE BOX |
| 2 | | 1 | FAN BASE CERAMIC SEAL - INSTALLED AT PLANT - FOR GREASE DUCTS |
| | | 1 | 2 YEAR PARTS WARRANTY |
| | | 1 | EVAPORATIVE COOLER WIRING HARNESS |
| 3 | MAU-1 | 1 | SEPARATE 120V WIRING PACKAGE (REQUIRED AND USED ONLY FOR DCV OR PREWIRE WITH VFD) — THREE PHASE ONLY |
| | | 1 | 2 YEAR PARTS WARRANTY |

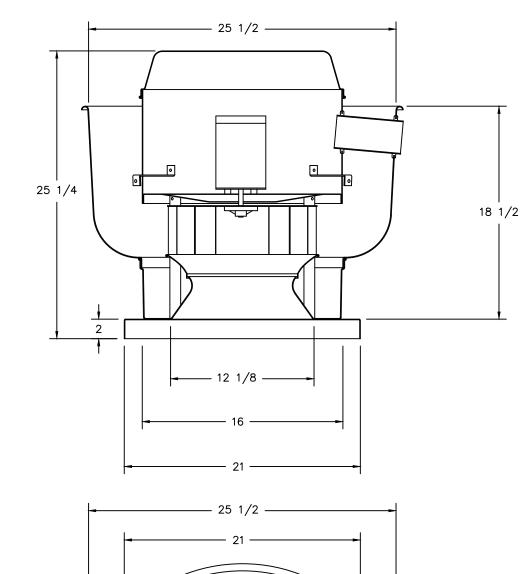
FAN ACCESSORIES

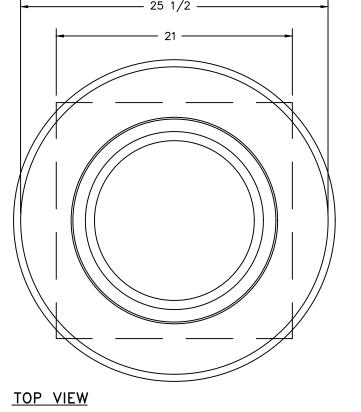
| | FAN UNIT NO | TAG | | EXHAUST | | SUPPLY | | | | | | |
|--|-------------------|------------|---------------|---------|---------------|-------------------|-------------------|---------------------|---------------|--|--|--|
| | | TAG | GREASE CUP | | WALL MOUNT | SIDE DISCHARGE | GRAVITY DAMPER | MOTORIZED DAMPER | WALL MOUNT | | | |
| | 1 | KEF-1 (B3) | | YES | | | | | | | | |
| | 2 | KEF-2 (D6) | YES | | | | | | | | | |
| | 3 | ΜΔΙΙ-1 | | | | | | | | | | |

| NO | ON FAN | TAG | WEIGHT | ITEM | SIZE |
|----|-----------|------------|--------|------|---|
| 1 | # 1 | KEF-1 (B3) | 30 LBS | CURB | 19.500"W X 19.500"L X 22.000"H ALONG LENGTH, RIGHT. |
| 2 | # 2 | KEF-2 (D6) | 48 LBS | CURB | 31.500"W X 31.500"L X 20.000"H ALONG LENGTH, RIGHT VENTED HINGED. |
| 3 | # 3 | MAU-1 | 52 LBS | CURB | 31.000"W X 31.000"L X 15.000"H ALONG LENGTH, RIGHT. |
| | # 3 | | | RAII | 4 000"W X 4 000"L X 36 000"H ALONG LENGTH RIGHT |



<u>FAN #1 DU33HFA — EXHAUST FAN (KEF—1 (B3))</u>

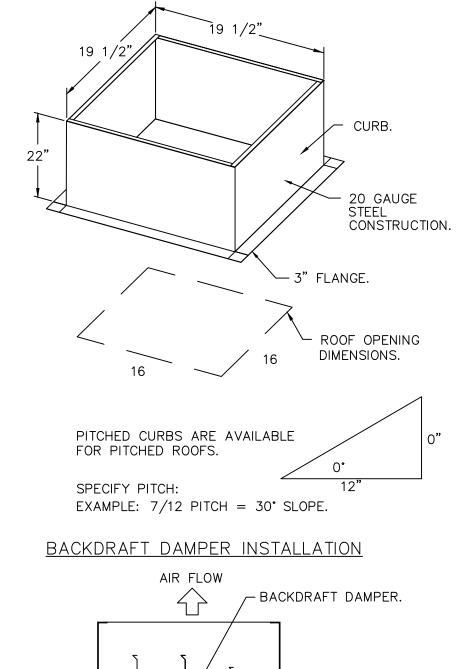




FEATURES:

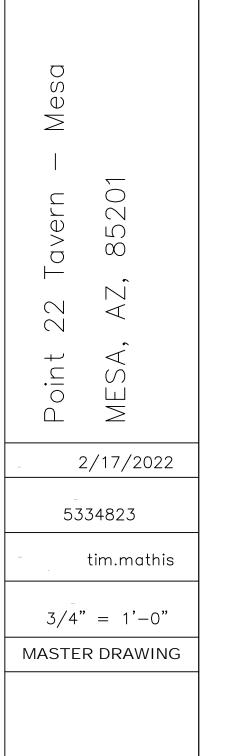
- DIRECT DRIVE CONSTRUCTION (NO BELTS/PULLEYS). - ROOF MOUNTED FANS.
- UL705. VARIABLE SPEED CONTROL.
- INTERNAL WIRING.
- THERMAL OVERLOAD PROTECTION (SINGLE PHASE).
- NEMA 3R SAFETY DISCONNECT SWITCH.

I 15-BDD DAMPER.
SCR-11 BIRD SCREEN.
ECM WIRING PACKAGE - MANUAL OR
0-10VDC REFERENCE SPEED CONTROL
(TELCO MOTOR), CCW ROTATION.
2 YEAR PARTS WARRANTY.



(ROOF OPENING).





VERIFY PITCH CURB Curb Pitch Required in order to manufacture the curb to specification.

| Point 22 Tavern — Mesa | MESA, AZ, 85201 | |
|------------------------|---------------------|--|
| | ∐ ≥ 2/17/2022 | |
| 53 | 34823 | |
| - | tim.mathis | |
| 3/4" | ' = 1'-0" | |
| MASTE | R DRAWING | |
| | 4 | |

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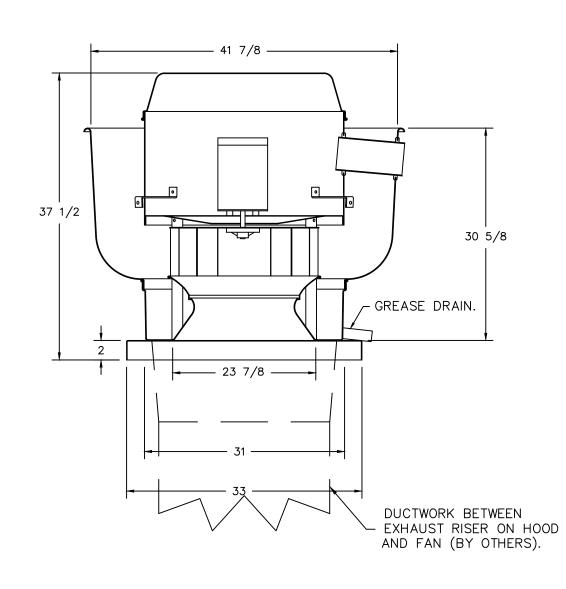
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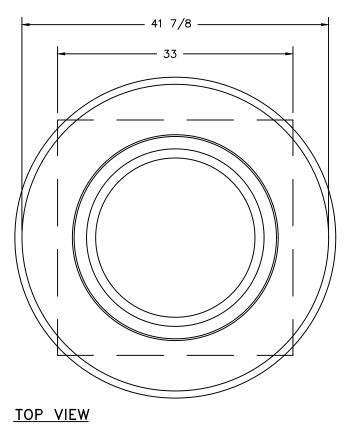
FAN #2 DU240HFA - EXHAUST FAN (KEF-2 (D6))

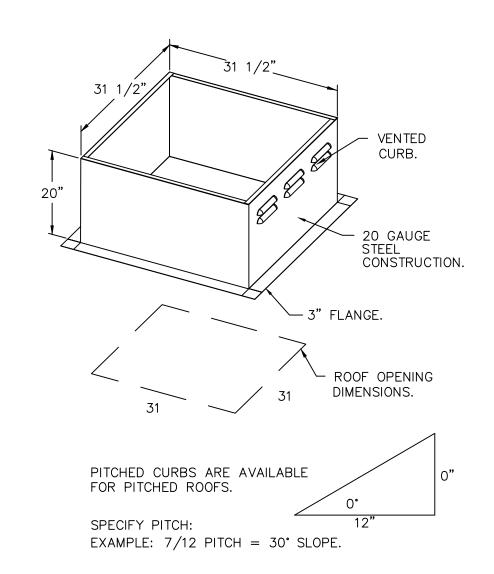


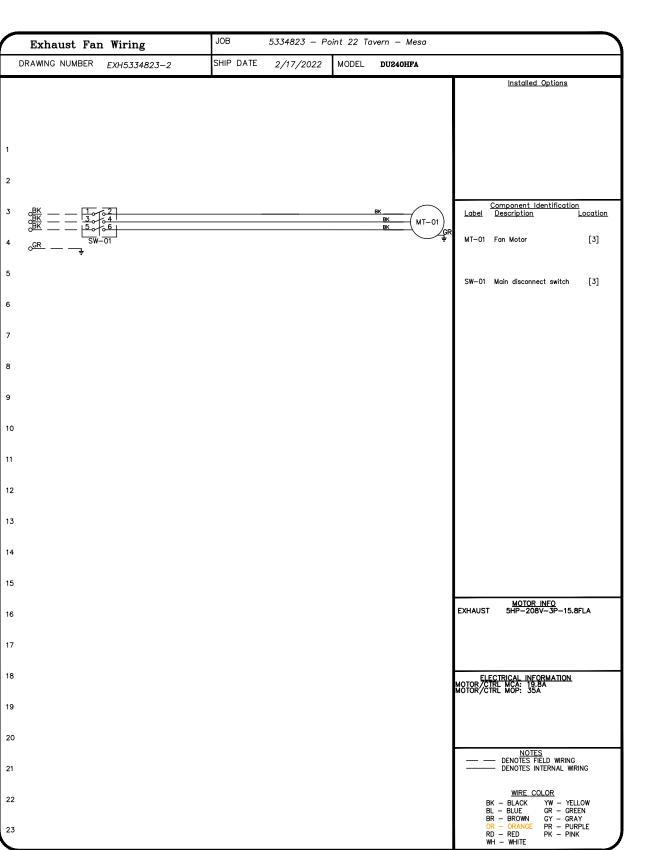
FEATURES:

- DIRECT DRIVE CONSTRUCTION (NO BELTS/PULLEYS).ROOF MOUNTED FANS.
- RESTAURANT MODEL.UL705 AND UL762 AND ULC-S645
- VARIABLE SPEED CONTROL.INTERNAL WIRING.
- THERMAL OVERLOAD PROTECTION (SINGLE PHASE).HIGH HEAT OPERATION 300°F (149°C).
- GREASE CLASSIFICATION TESTING.NEMA 3R SAFETY DISCONNECT SWITCH.
- NORMAL TEMPERATURE TEST
 EXHAUST FAN MUST OPERATE CONTINUOUSLY
 WHILE EXHAUSTING AIR AT 300°F (149°C)
 UNTIL ALL FAN PARTS HAVE REACHED
 THERMAL EQUILIBRIUM, AND WITHOUT ANY
 DETERIORATING EFFECTS TO THE FAN WHICH
 WOULD CAUSE UNSAFE OPERATION.
- ABNORMAL FLARE—UP TEST

 EXHAUST FAN MUST OPERATE CONTINUOUSLY
 WHILE EXHAUSTING BURNING GREASE VAPORS
 AT 600°F (316°C) FOR A PERIOD OF
 15 MINUTES WITHOUT THE FAN BECOMING
 DAMAGED TO ANY EXTENT THAT COULD CAUSE
 AN UNSAFE CONDITION.
- <u>OPTIONS</u>
- GREASE BOX. FAN BASE CERAMIC SEAL — INSTALLED AT PLANT — FOR GREASE DUCTS. 2 YEAR PARTS WARRANTY.









22

Point

2/17/2022

A R I Z O N S ULTING
7920 E. OAK STREET - SCOTTSDALE, ARIZONA 85257
602.699.5131

SHOUINARD DESIGN STUDIO
7234 E SHOEMAN LANE #7
SCOTTSDALE, ARIZONA 85251
(480) 947-4992

AT 22 TAVERN

B. CADENCE PKWY

A, ARIZONA 85212

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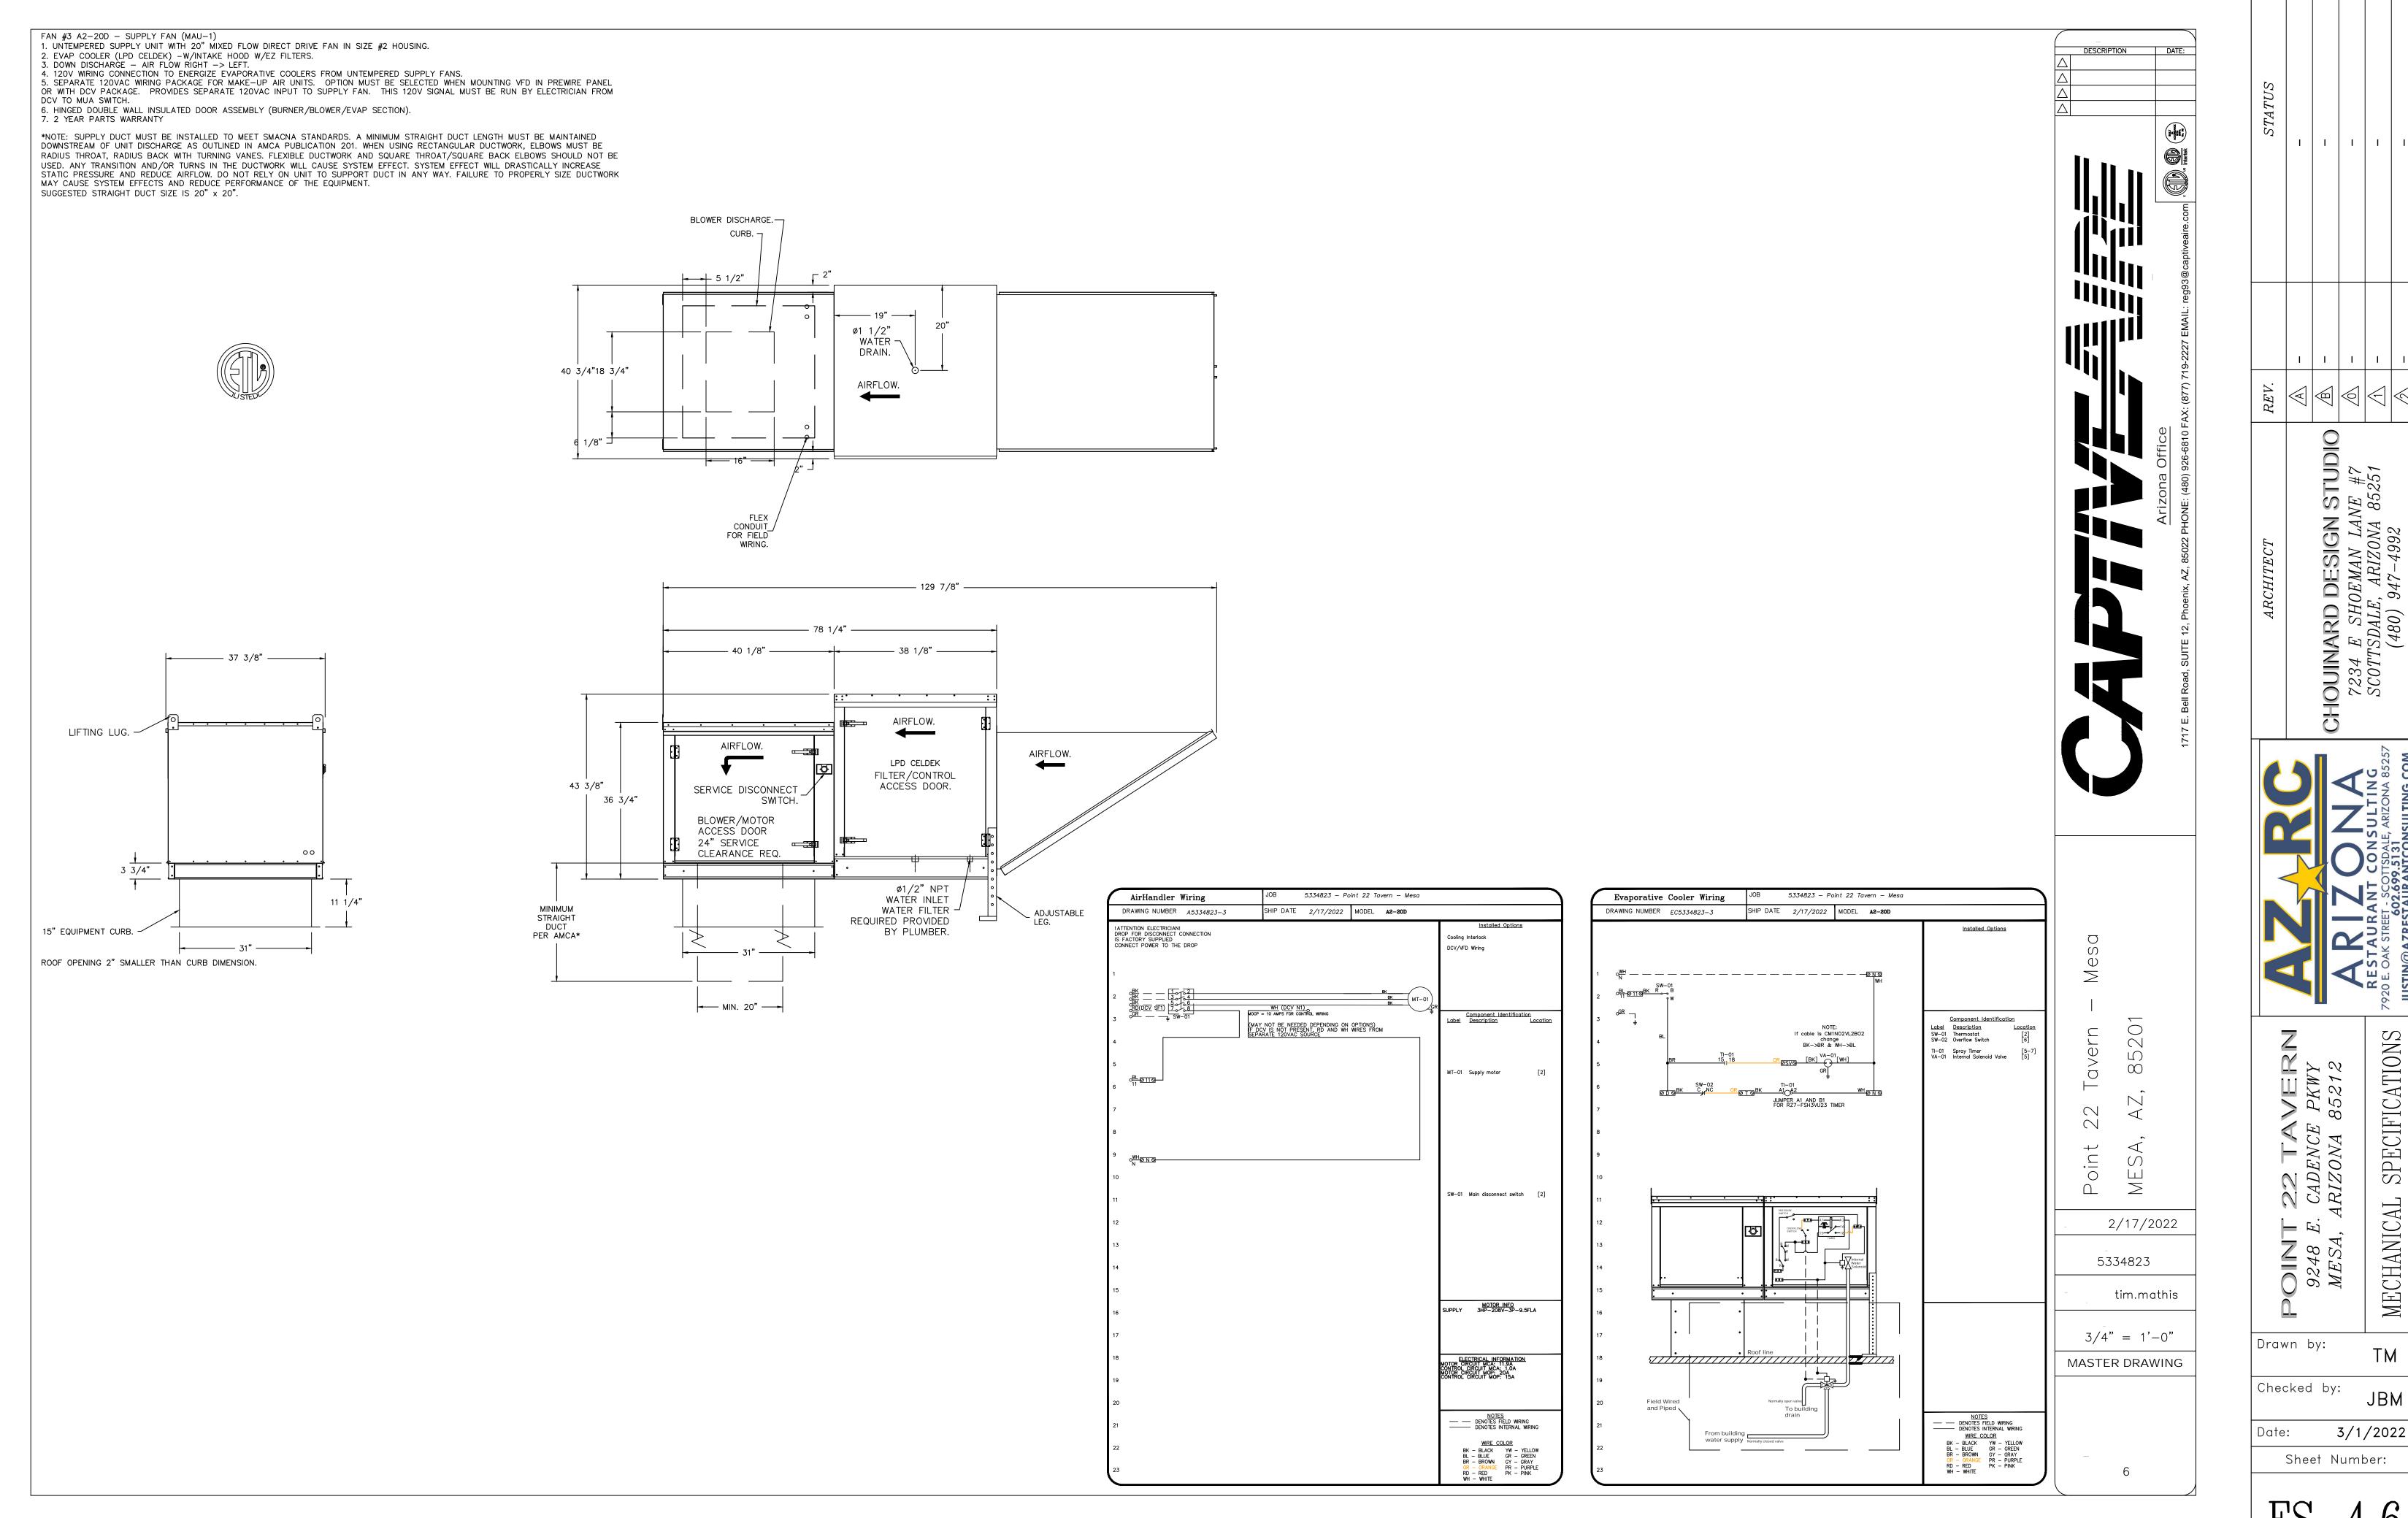
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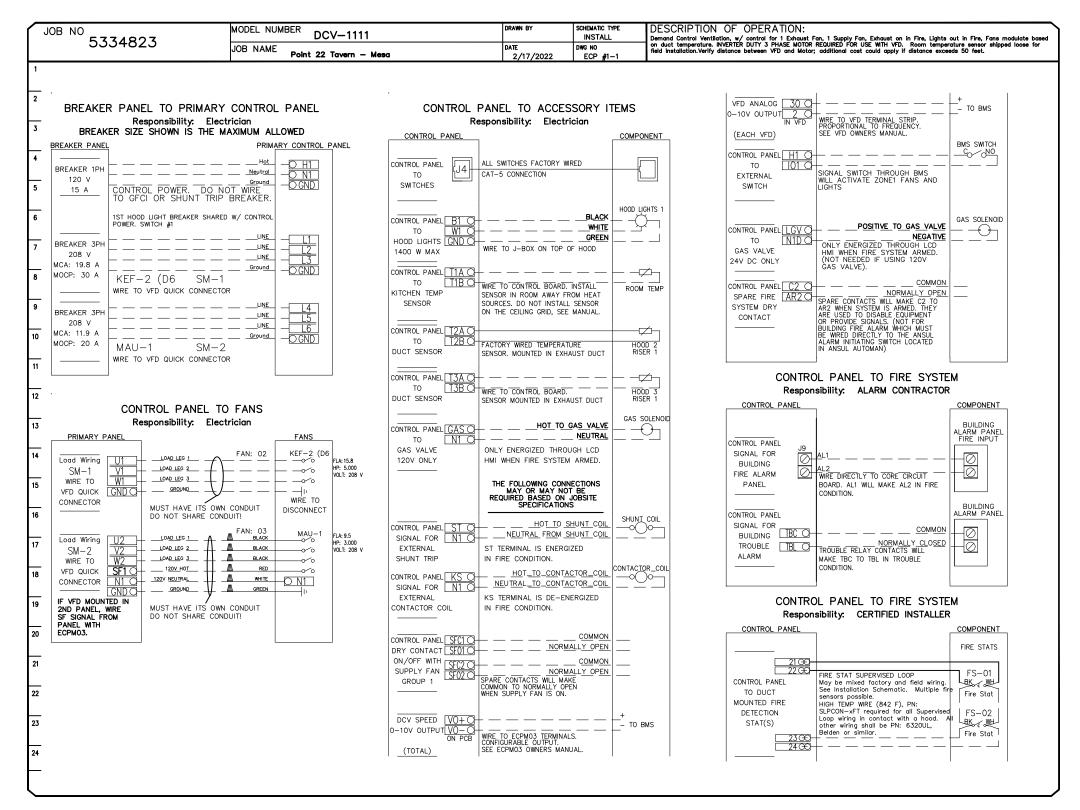
FS-4.5

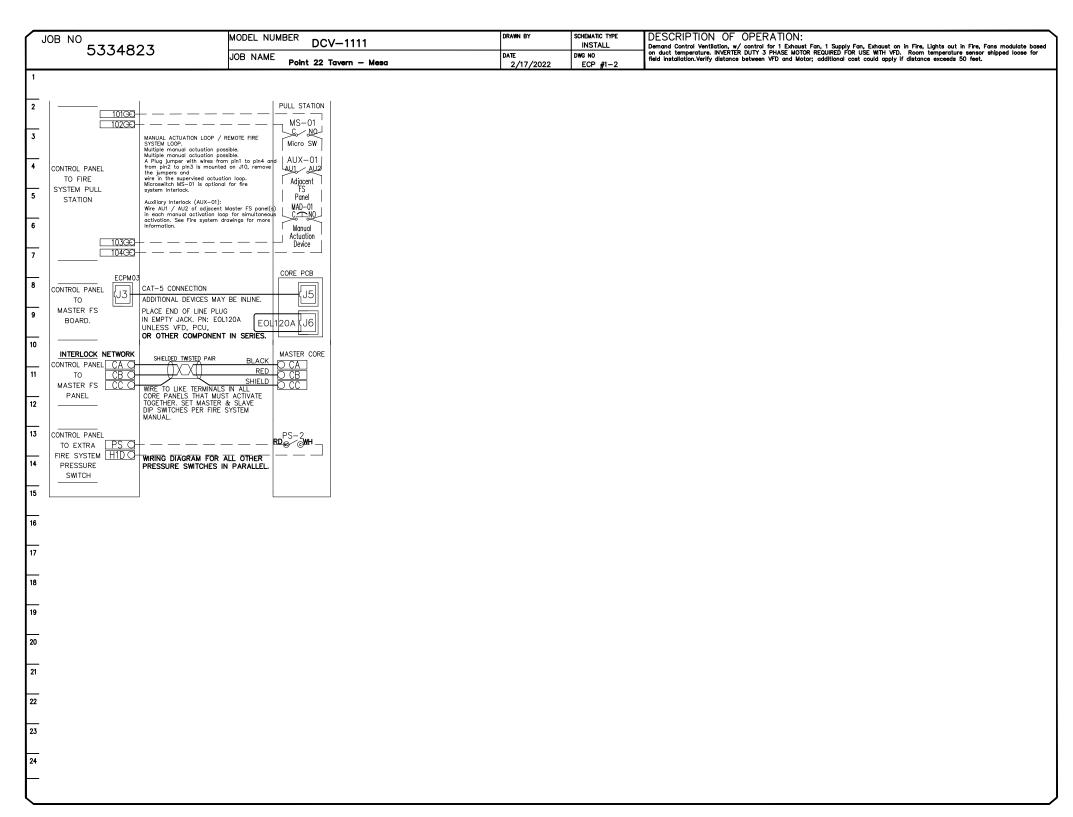


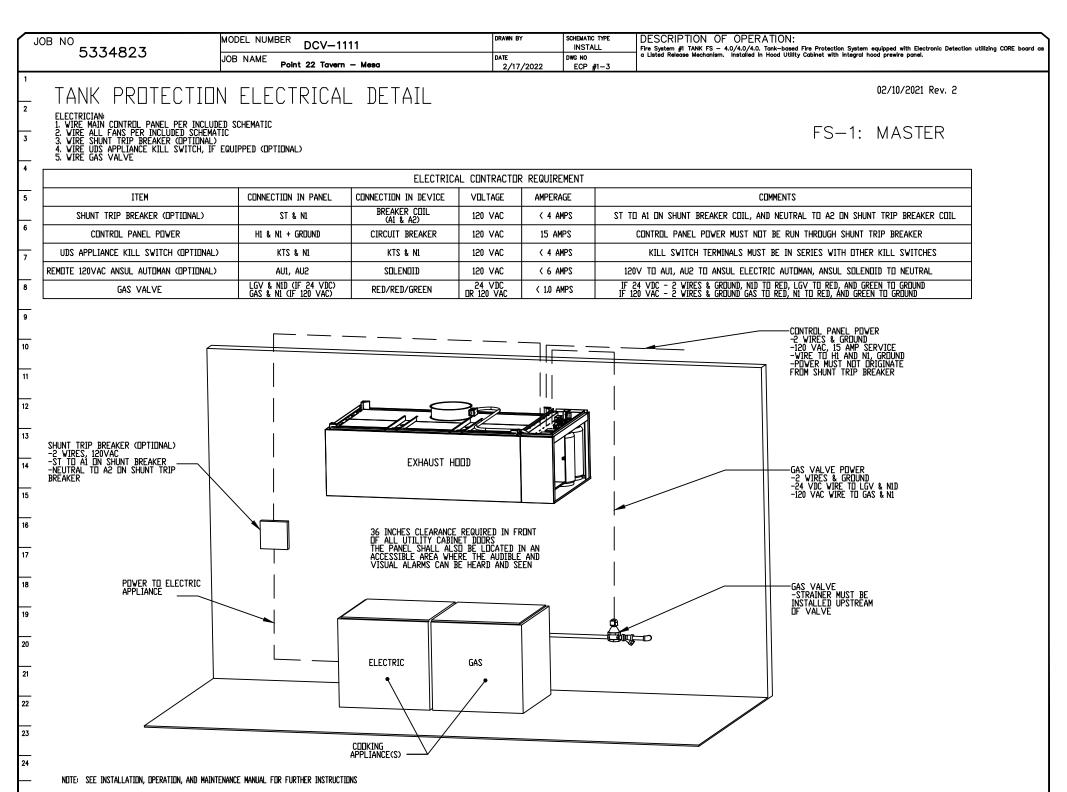
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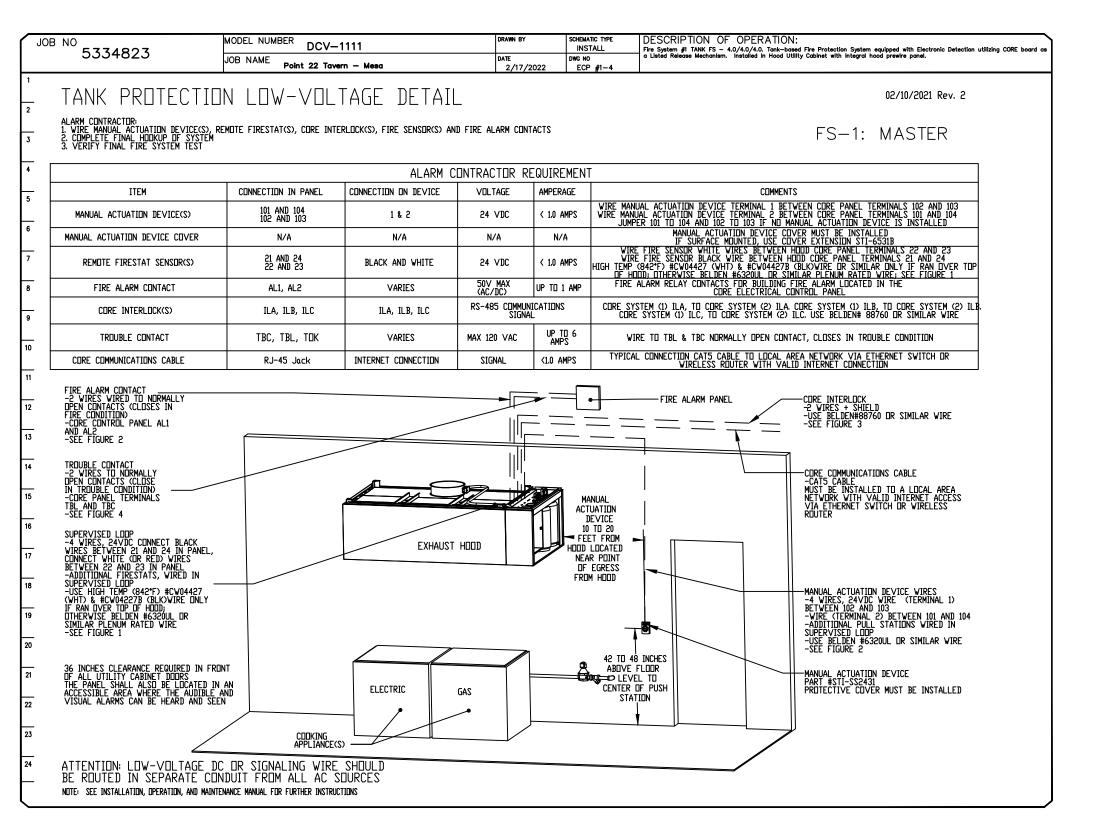
FS-4.6

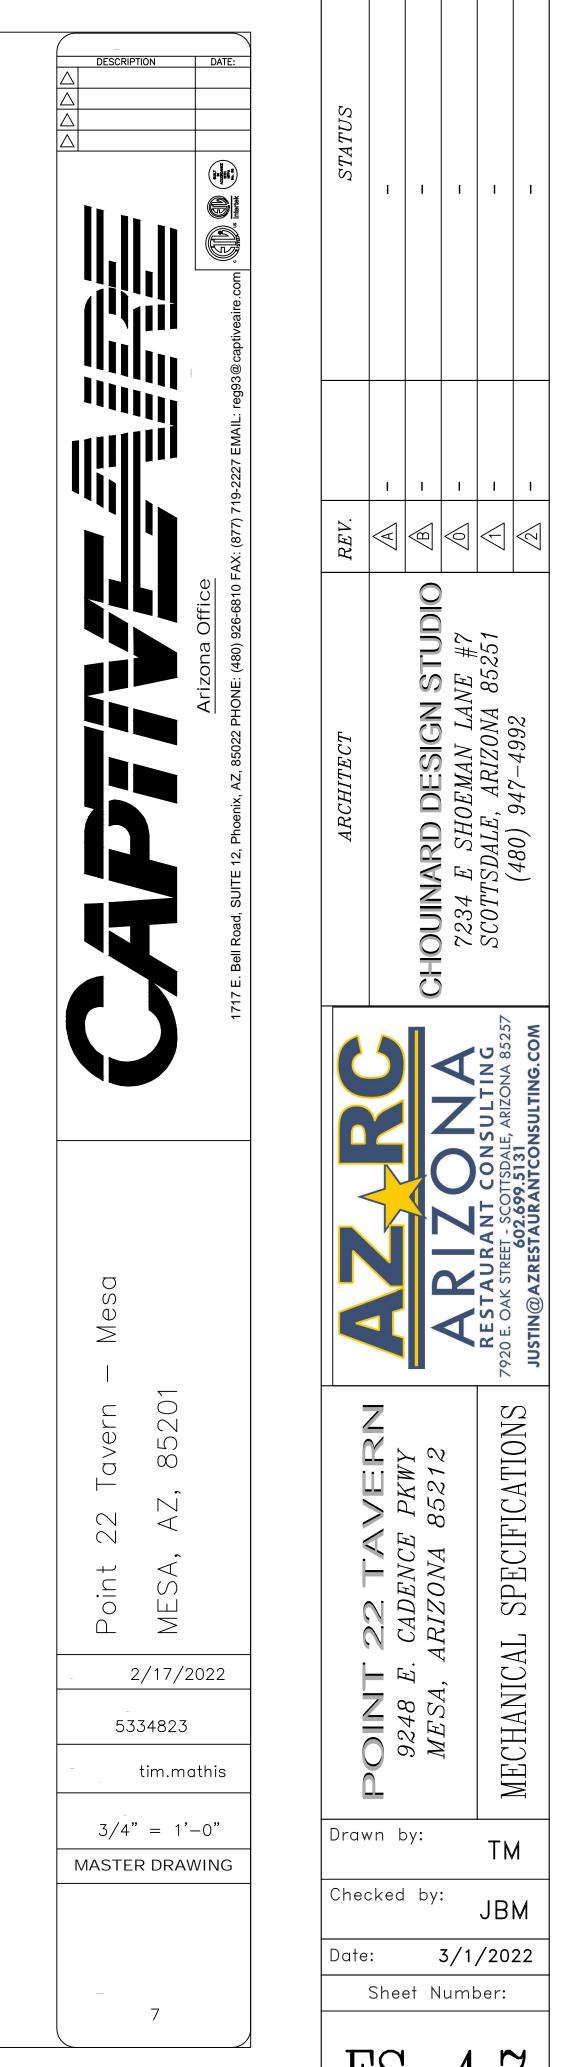
| EL | <i>ECTRICAL</i> | PACKAGE | E - J0B#5334823 | | | | | | | | | |
|----|-----------------|-----------|----------------------|----------------------|----------|--------------------|-----------------|---------|---|-------|------|------|
| NO | TAG | PACKAGE # | LOCATION | SWITCH | ES | OPTION | FANS CONTROLLED | | | | | |
| | .,,, | " | 2007177011 | LOCATION | QUANTITY | 5, | FAN TAG | TYPE | ф | HP | VOLT | FLA |
| | 1 201/ | DCV-1111 | LITHITY CADINET LEET | 03 - UTILITY CABINET | 1 LIGHT | SMART CONTROLS DCV | KEF-2 (D6) | EXHAUST | 3 | 5.000 | 208 | 15.8 |
| | | DCV-IIII | UTILITY CABINET LEFT | HOOD # 2 | 1 FAN | SMART CONTROLS DCV | MAU-1 | SUPPLY | 3 | 3.000 | 208 | 9.5 |



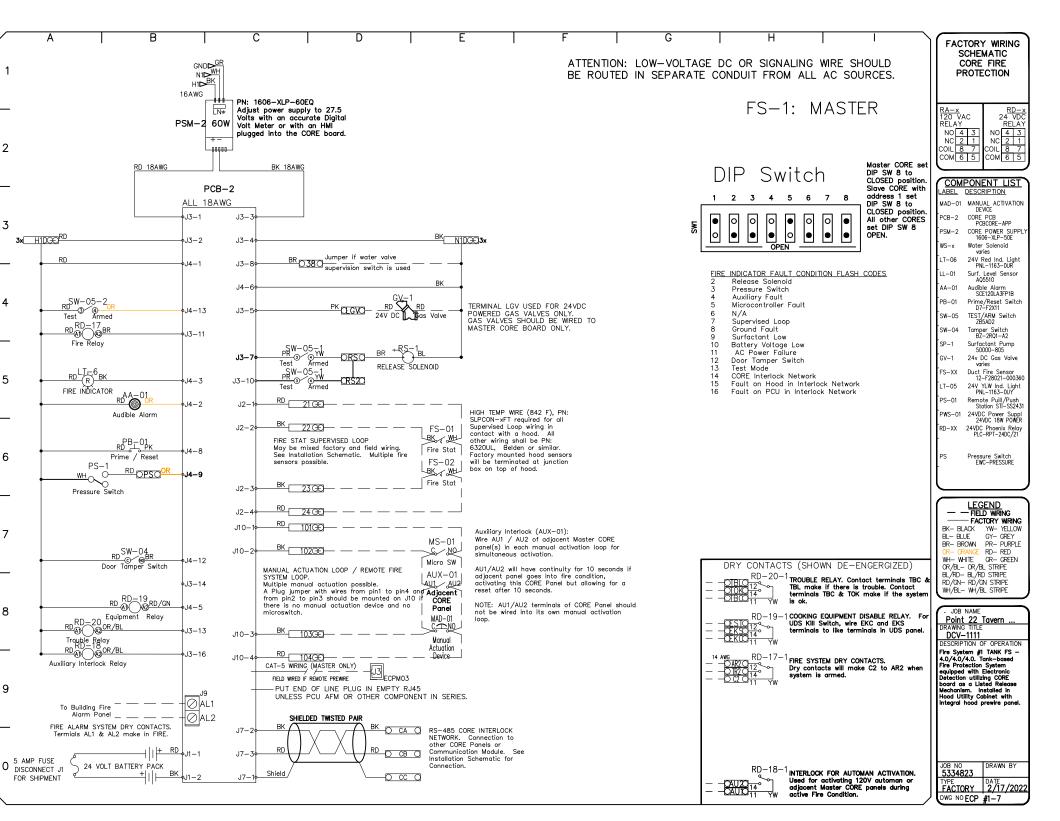


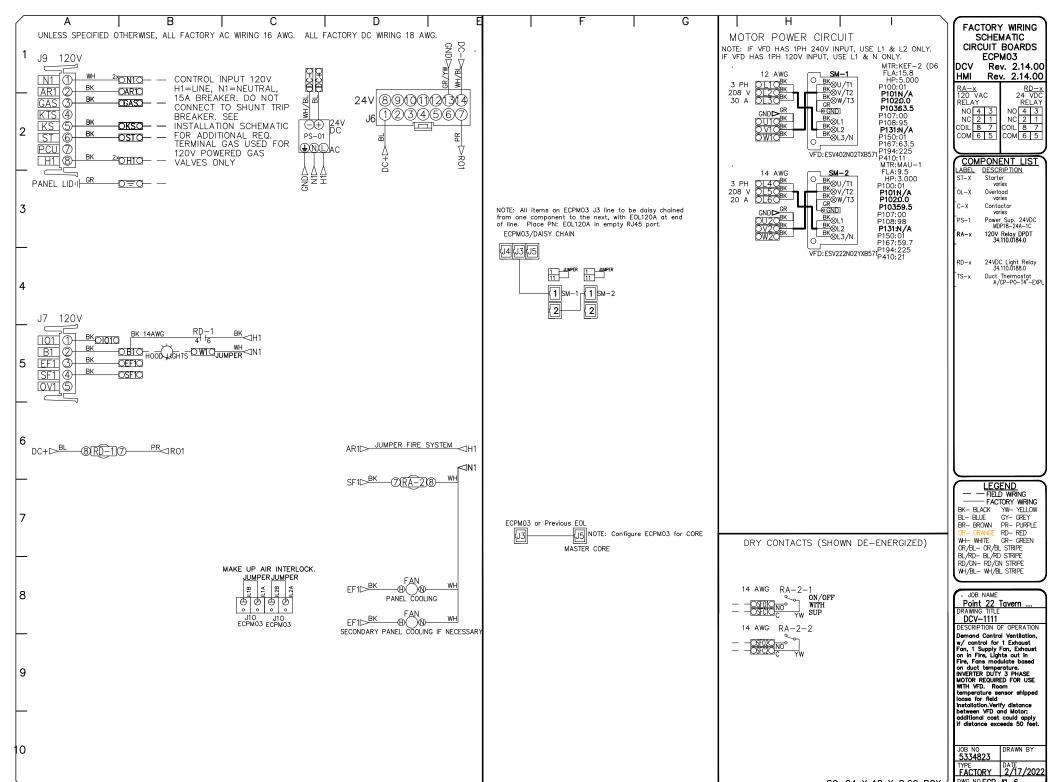






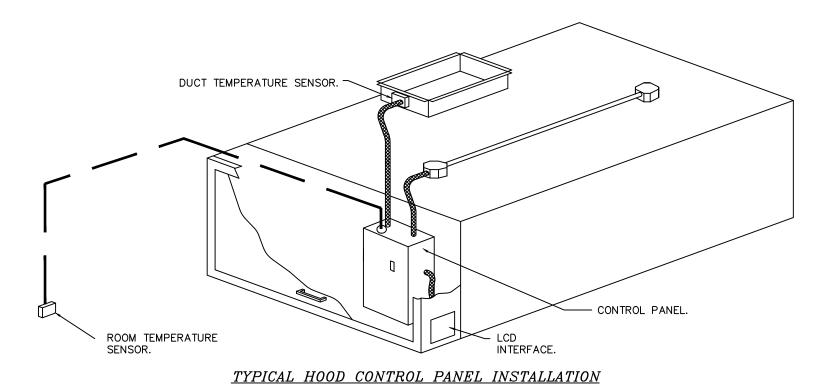
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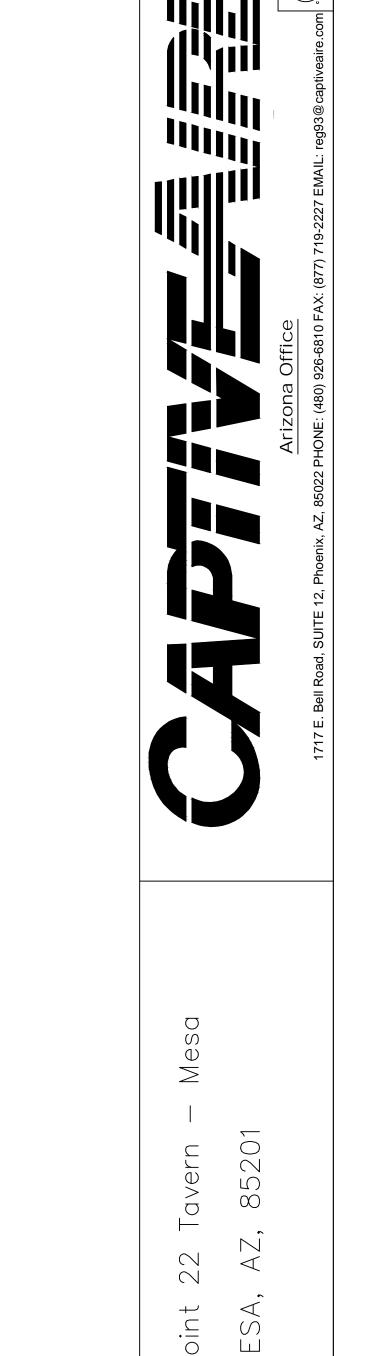
DEMAND CONTROL VENTILATION HOOD CONTROL PANEL SPECIFICATIONS CONTROLS SHALL BE LISTED BY ETL (UL 508A) AND SHALL COMPLY WITH DEMAND VENTILATION SYSTEM

- TURNDOWN REQUIREMENTS OUTLINED IN IECC 403.2.8 (2015) - THE CONTROL ENCLOSURE SHALL BE NEMA 1 RATED AND LISTED FOR INSTALLATION INSIDE OF THE
- EXHAUST HOOD UTILITY CABINET. THE CONTROL ENCLOSURE MAY BE CONSTRUCTED OF STAINLESS STEEL
- TEMPERATURE PROBE(S) LOCATED IN THE EXHAUST DUCT RISER(S) SHALL BE CONSTRUCTED OF STAINLESS STEEL.
- A DIGITAL CONTROLLER SHALL BE PROVIDED TO ACTIVATE THE HOOD EXHAUST FANS DYNAMICALLY BASED ON A FIXED DIFFERENTIAL BETWEEN THE AMBIENT AND DUCT TEMPERATURES SENSORS. THIS FUNCTION SHALL MEET THE REQUIREMENTS OF IMC 507.1.1.
- A DIGITAL CONTROLLER SHALL PROVIDE ADJUSTABLE HYSTERESIS SETTINGS TO PREVENT CYCLING OF THE FANS AFTER THE COOKING APPLIANCES HAVE BEEN TURNED OFF AND/OR THE HEAT IN THE EXHAUST SYSTEM IS REDUCED.
- A DIGITAL CONTROLLER SHALL PROVIDE AN ADJUSTABLE MINIMUM FAN RUN-TIME SETTING TO PREVENT FAN
- VARIABLE FREQUENCY DRIVES (VFDS) SHALL BE PROVIDED FOR FANS AS REQUIRED. THE DIGITAL CONTROLLER SHALL MODULATE THE VFDS BETWEEN A MINIMUM SETPOINT AND A MAXIMUM SETPOINT ON DEMAND. THE DUCT TEMPERATURE SENSOR INPUT(S) TO THE DIGITAL CONTROLLER SHALL BE USED TO CALCULATE THE SPEED REFERENCE SIGNAL.
- THE VFD SPEED RANGE OF OPERATION SHALL BE FROM 0% TO 100% FOR THE SYSTEM, WITH THE ACTUAL MINIMUM SPEED SET AS REQUIRED TO MEET MINIMUM VENTILATION REQUIREMENTS.
- AN INTERNAL ALGORITHM TO THE DIGITAL CONTROLLER SHALL MODULATE SUPPLY FAN VFD SPEED PROPORTIONAL TO ALL EXHAUST FANS THAT ARE LOCATED IN THE SAME FAN GROUP AS THE SUPPLY FAN.
- THE SYSTEM SHALL OPERATE IN PREP MODE DURING LIGHT COOKING LOAD OR COOL DOWN MODE WHEN SUFFICIENT HEAT REMAINS UNDERNEATH THE HOOD SYSTEM AFTER COOKING OPERATIONS HAVE COMPLETED. OPERATION DURING EITHER OF THESE PERIODS WILL DISABLE THE SUPPLY FANS AND PROVIDE AN EXHAUST FAN SPEED THAT IS EQUAL TO THE MINIMUM VENTILATION REQUIREMENT.
- A DIGITAL CONTROLLER SHALL DISABLE THE SUPPLY FAN(S), ACTIVATE THE EXHAUST FAN(S), ACTIVATE THE APPLIANCE SHUNT TRIP, AND DISABLE AN ELECTRIC GAS VALVE AUTOMATICALLY WHEN FIRE CONDITION IS DETECTED ON A COVERED HOOD.
- A DIGITAL CONTROLLER SHALL ALLOW FOR EXTERNAL BMS FAN CONTROL VIA DRY CONTACT (EXTERNAL CONTROL SHALL NOT OVERRIDE FAN OPERATION LOGIC AS REQUIRED BY CODE).
- AN LCD INTERFACE SHALL BE PROVIDED WITH THE FOLLOWING FEATURES:
- A. ON/OFF PUSH BUTTON FAN & LIGHT SWITCH ACTIVATION.
- B. INTEGRATED GAS VALVE RESET FOR ELECTRONIC GAS VALVES (NO RESET RELAY REQUIRED). C. VFD FAULT DISPLAY WITH AUDIBLE & VISUAL ALARM NOTIFICATION.
- D. DUCT TEMPERATURE SENSOR FAILURE DETECTION WITH AUDIBLE & VISUAL ALARM NOTIFICATION.
- E. MIS-WIRED DUCT TEMPERATURE SENSOR DETECTION WITH AUDIBLE & VISUAL ALARM NOTIFICATION.
- F. A SINGLE LOW VOLTAGE CAT-5 RJ45 WIRING CONNECTION. G. AN ENERGY SAVINGS INDICATOR THAT UTILIZES MEASURED KWH FROM THE VFDS.



SEQUENCE OF OPERATIONS: THE HOOD CONTROL PANEL IS CAPABLE OF OPERATING IN ONE OR MORE OF THE FOLLOWING STATES AT ANY

- AUTOMATIC: THE SYSTEM OPERATES BASED ON THE DIFFERENTIAL BETWEEN ROOM TEMPERATURE AND THE TEMPERATURE AT THE HOOD CAVITY OR EXHAUST DUCT COLLAR. FANS ACTIVATE AT A CONFIGURABLE TEMPERATURE DIFFERENTIAL THRESHOLD. DEPENDING ON THE JOB CONFIGURATION EACH FAN ZONE CAN BE CONFIGURED AS STATIC OR DYNAMIC. THESE TERMS REFER TO WHETHER A VARIABLE MOTOR (SUCH AS EC MOTORS OR VFD DRIVEN MOTORS) MODULATE WITH TEMPERATURE. IF THE PANEL IS EQUIPPED WITH VARIABLE SPEED FANS AND THE ZONE IS DEFINED AS "DYNAMIC", THESE WILL MODULATE WITHIN A USER-DEFINED RANGE BASED ON THE TEMPERATURE DIFFERENTIAL. PANELS EQUIPPED WITH VARIABLE SPEED FANS AND A FAN ZONE DEFINED AS "STATIC", FANS WILL RUN AT A SET SPEED CALCULATED FOR THE DRIVE. DEMAND CONTROL VENTILATION SYSTEMS ARE CAPABLE OF MODULATING EXHAUST AND MAKE UP AIR FAN SPEEDS PER THE REQUIREMENTS OUTLINED IN IECC 403.2.8.
- MANUAL: THE SYSTEM OPERATES BASED ON HUMAN INPUT FROM AN HMI.
- SCHEDULE: A WEEKLY SCHEDULE CAN BE SET TO RUN FANS FOR A SPECIFIED PERIOD THROUGHOUT THE DAY. THERE ARE THREE OCCUPIED TIMES PER DAY TO ALLOW FOR THE USER TO SET UP A TIME THAT IS SUITABLE TO THEIR NEEDS. ANY TIME THAT IS WITHIN THE DEFINED OCCUPIED TIME, THE SYSTEM WILL RUN AT MODULATION MODE AND FOLLOW THE FAN PROCEDURE ALGORITHM BASED ON TEMPERATURE DURING THIS TIME. DURING UNOCCUPIED TIME, THE SYSTEM WILL HAVE AN EXTRA OFFSET TO PREVENT UNINTENDED ACTIVATION OF THE SYSTEM DURING A TIME WHERE THE SYSTEM IS NOT BEING OCCUPIED.
- OTHER: THE SYSTEM OPERATES BASED ON THE INPUT FROM AN EXTERNAL SOURCE (DDC, BMS OR HARD-WIRED INTERLOCK).
- FIRE: UPON ACTIVATION OF THE HOOD FIRE SUPPRESSION SYSTEM, THE EXHAUST FAN WILL COME ON OR CONTINUE TO TO RUN, THE HOOD MAKEUP AIR WILL SHUTDOWN, AND A SIGNAL WILL BE SENT FOR ACTIVATING THE SHUNT TRIP BREAKER PROVIDED BY THE ELECTRICIAN. FUEL GAS WILL SHUT OFF VIA A MECHANICAL/ELECTRICAL GAS VALVE ACTUATED BY THE HOOD FIRE SUPPRESSION SYSTEM.



| | ce | 110 FAX: (877) 719- | REV. |
|---|----------------|---|-----------|
| | Arizona Office | 1717 E. Bell Road, SUITE 12, Phoenix, AZ, 85022 PHONE: (480) 926-6810 FAX: (877) 719- | ARCHITECT |
| Point 22 Tavern - Mesa MESA, AZ, 85201 | | 17/ | |
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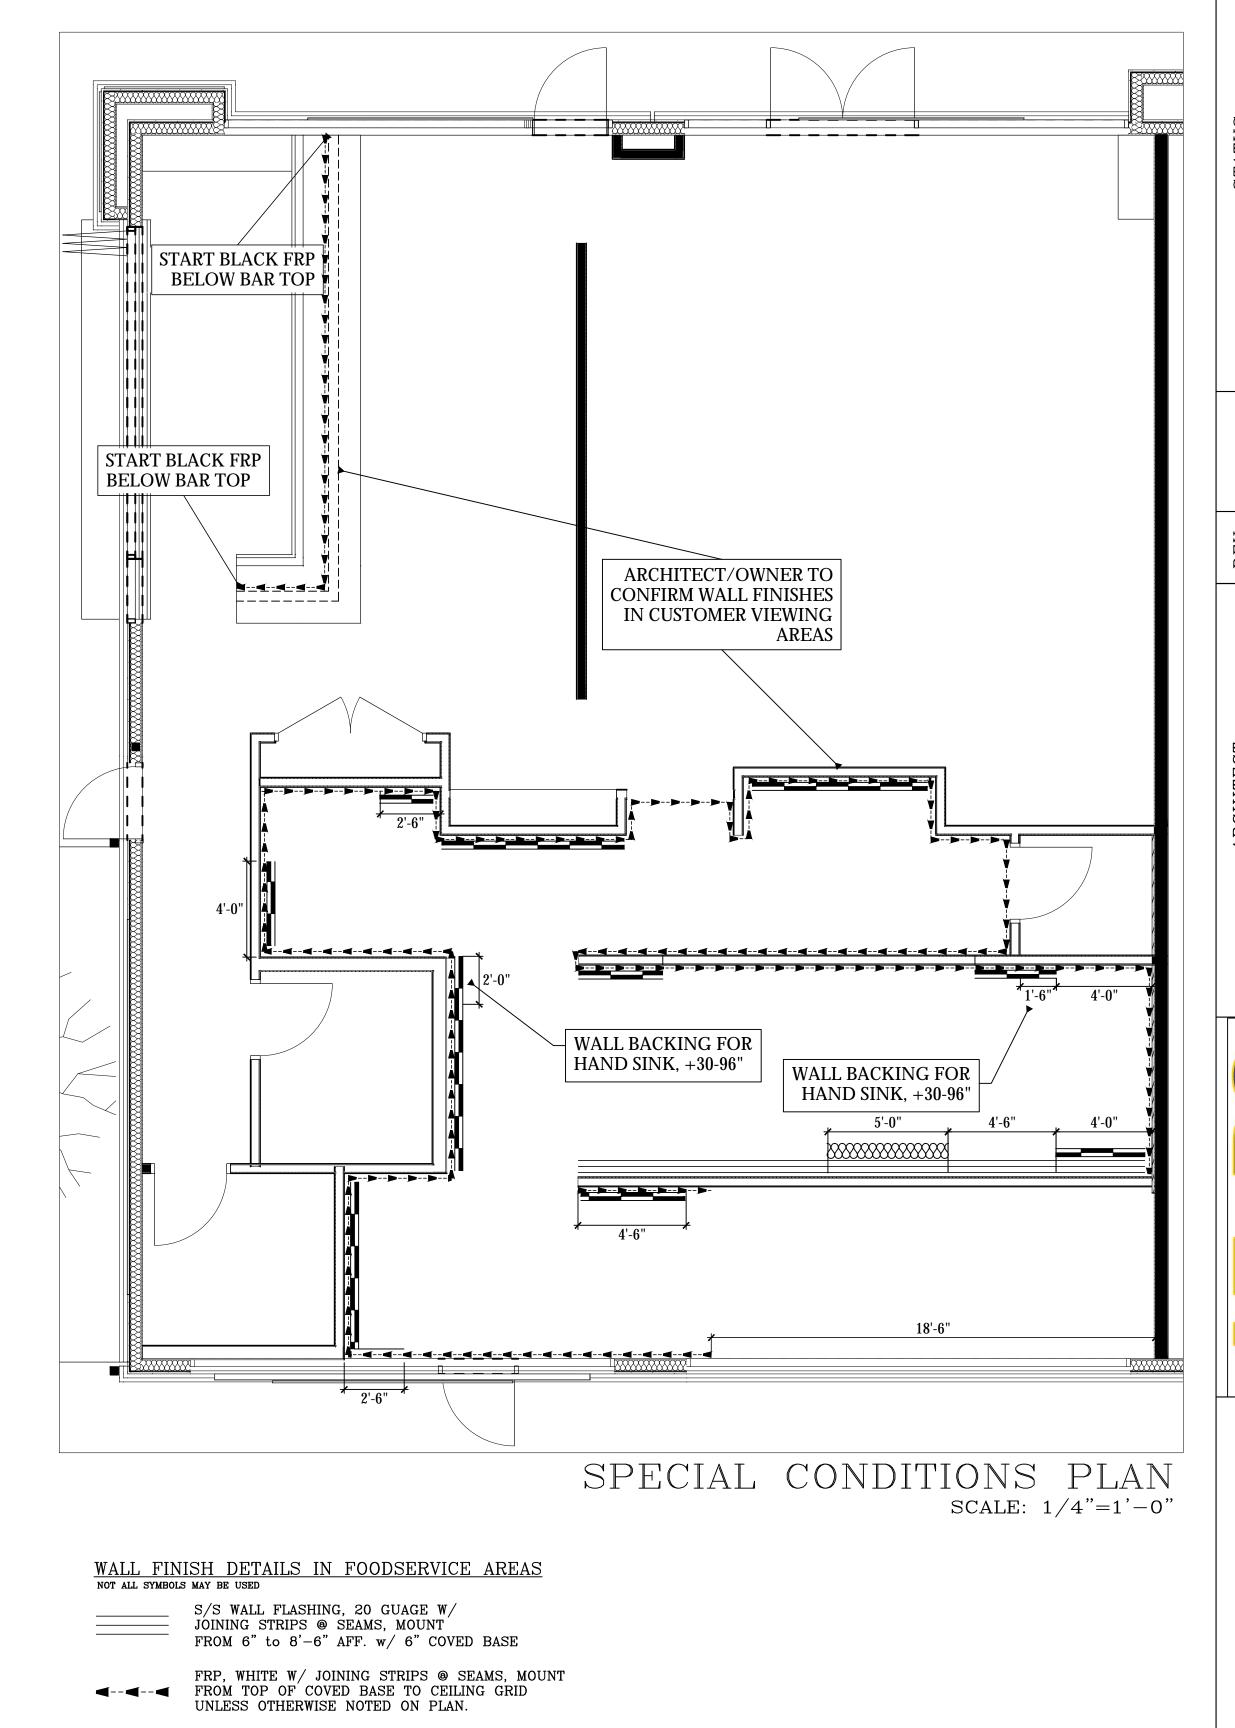
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(480) 947-4992

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EPOXY PAINT, NSF APPROVED OVER BLOCK CONSTRUCTION AS APPROVED BY HEALTH DEPARTMENT.

WALL BACKING DETAILS IN FOODSERVICE AREAS NOT ALL SYMBOLS MAY BE USED

%" PLYWOOD WALL BACKING, IN LIEU OF SHEETROCK FROM 4'-0" TO 8'-0" UNLESS OTHERWISE NOTED ON PLAN

NON-COMBUSTIBLE WALL BACKING, TBD BY GC, BEHIND SHEETROCK FROM 4'-0" TO 8'-0" UNLESS OTHERWISE NOTED ON PLAN

F 22 T AV E. CADENCE PI ARIZONA 85,

POINT 22 T 9248 E. CADEN MESA, ARIZON CONDITIONS

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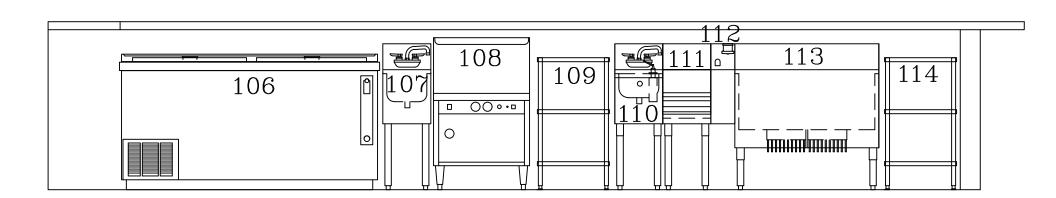
Checked by:

Date: 3/1/2022

Sheet Number:

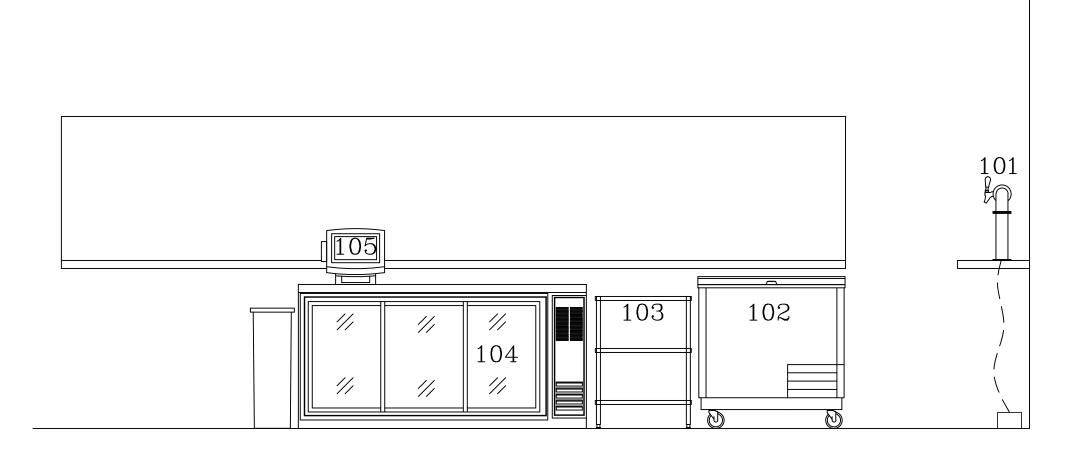
FS-5.0

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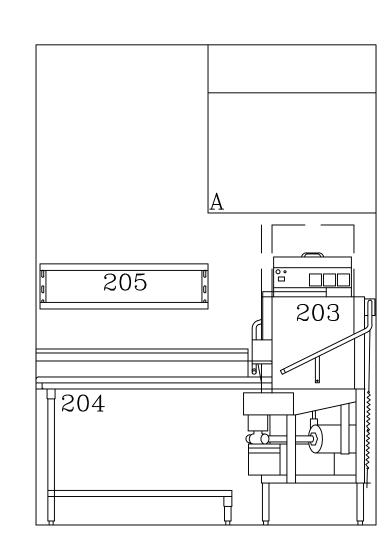
BAR AREA - EAST

SCALE: 1/2"=1'-0"



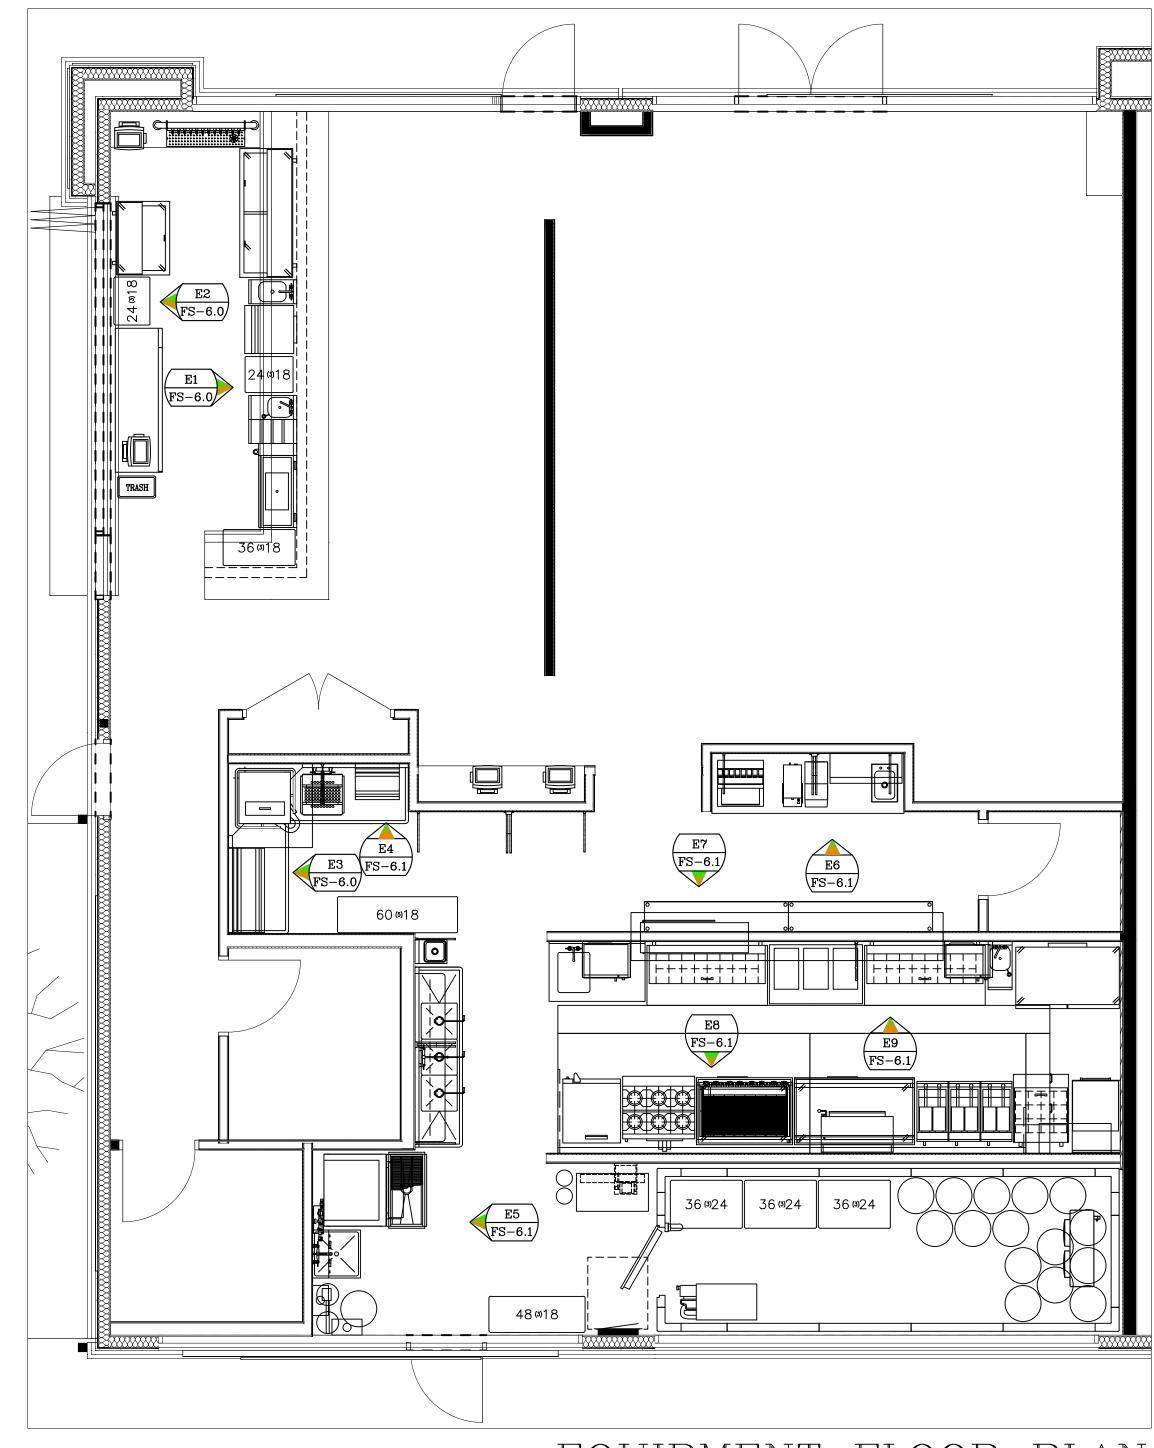
(E2) BACK BAR AREA - WEST

SCALE: 1/2"=1'-0"



E3 DISH AREA — WEST scale: 1/2"=1'-0"



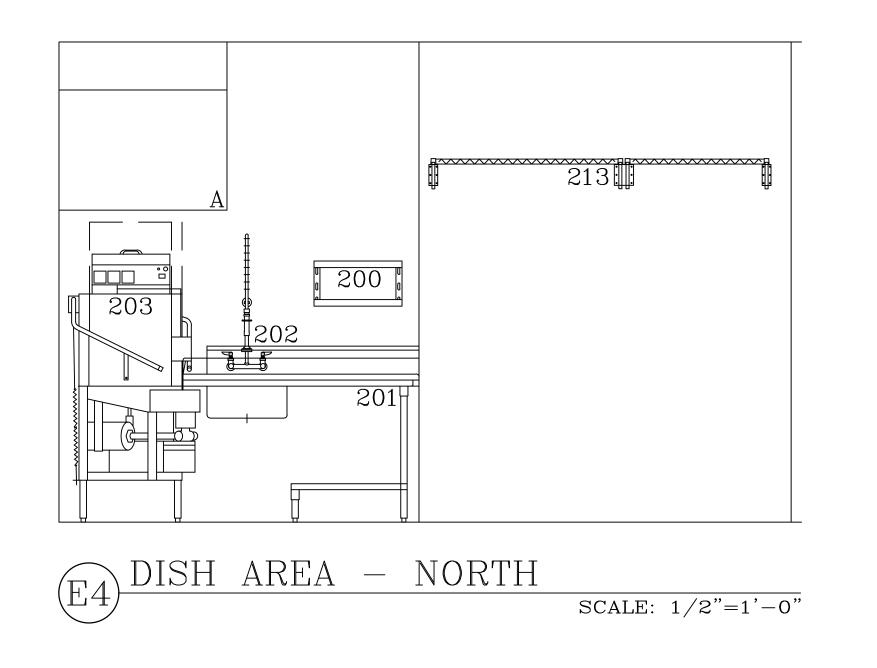


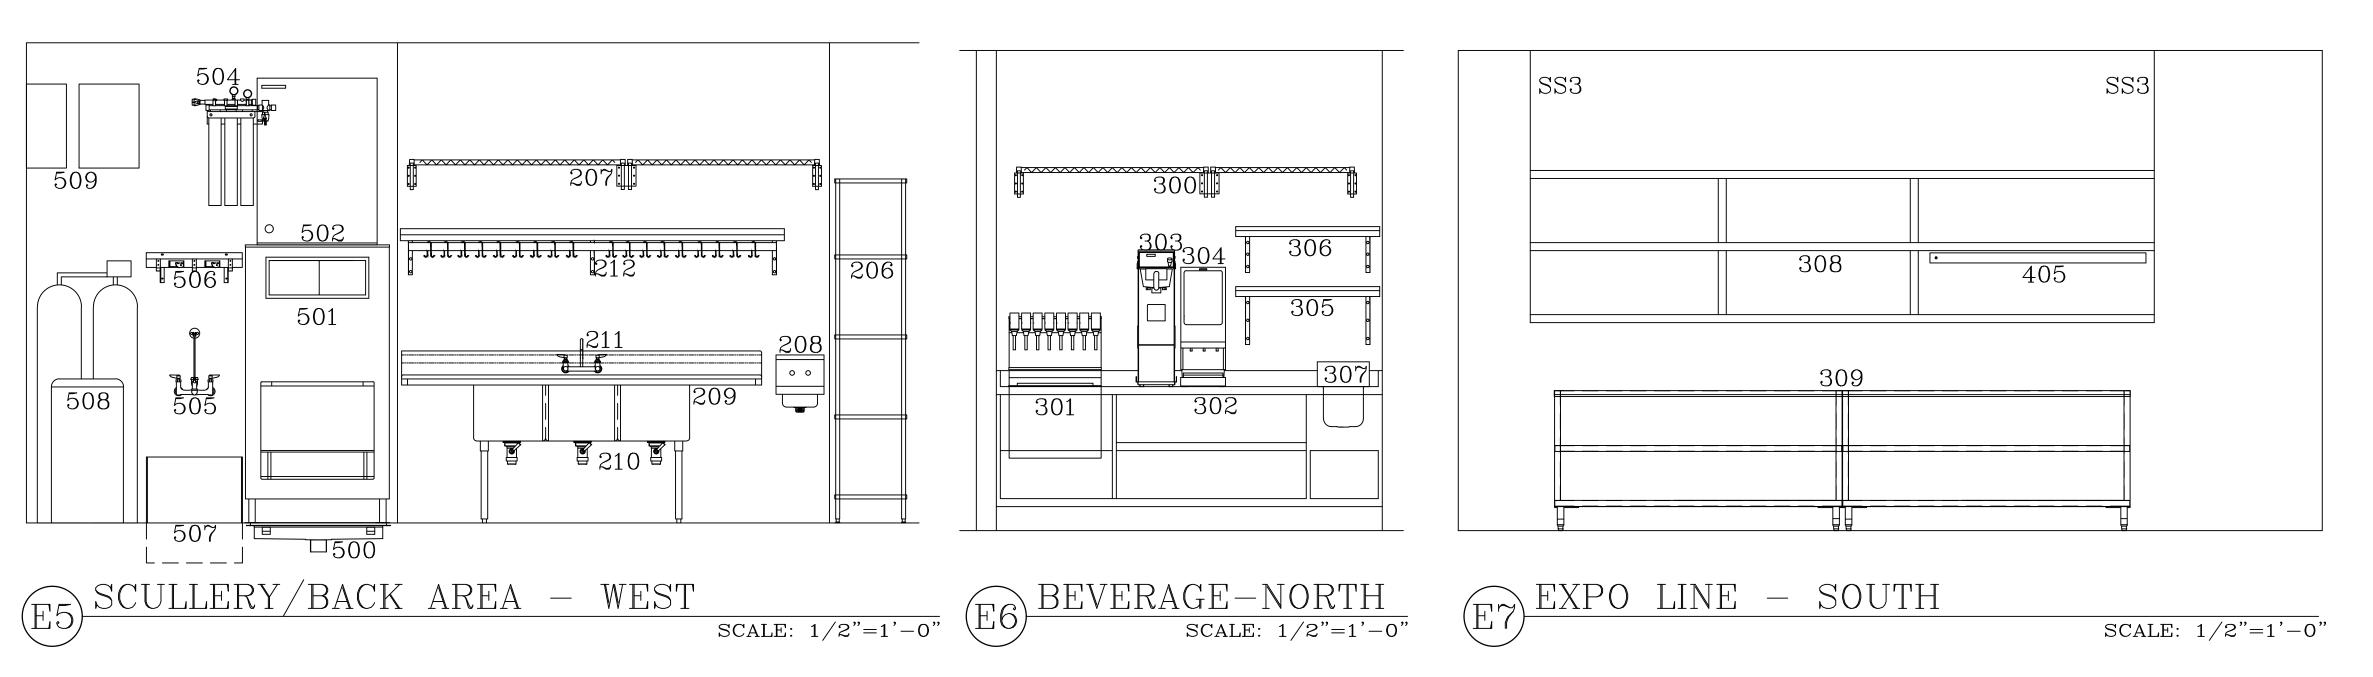
EQUIPMENT FLOOR PLAN SCALE: 1/4"=1'-0"

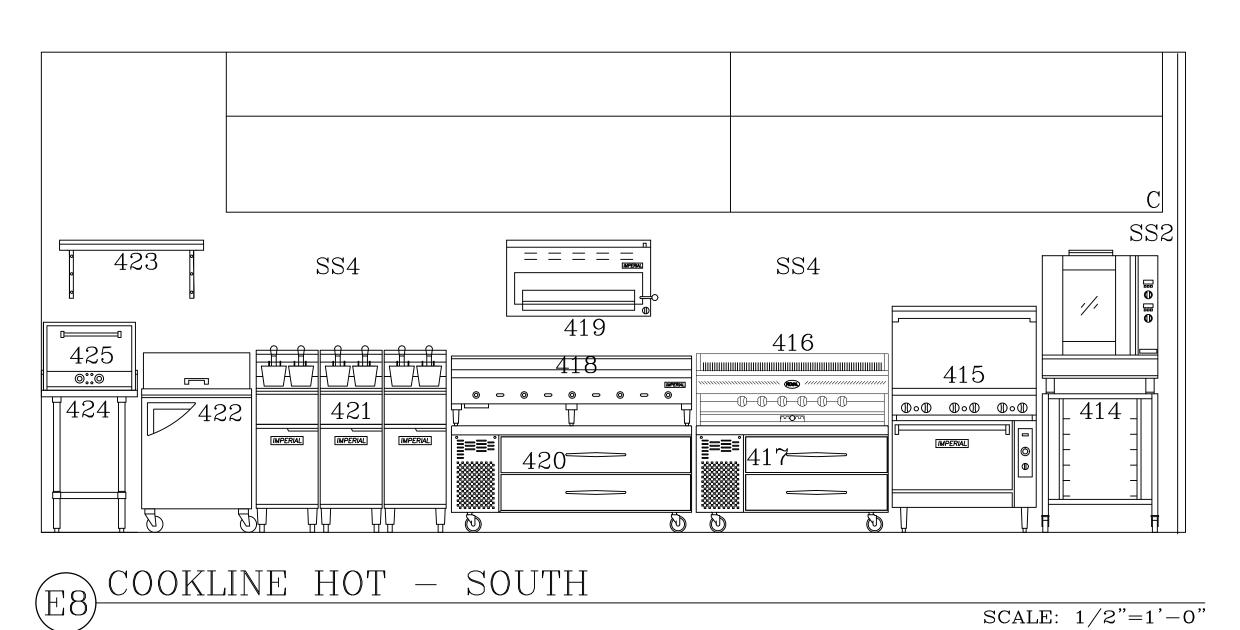
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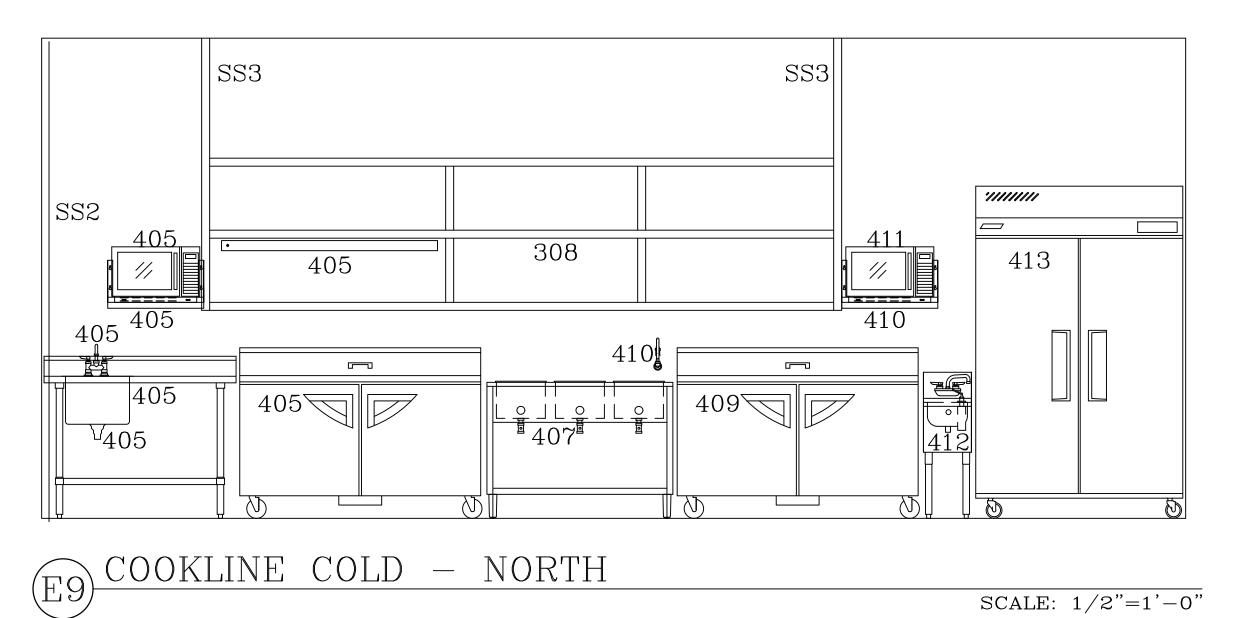
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FS-6.0



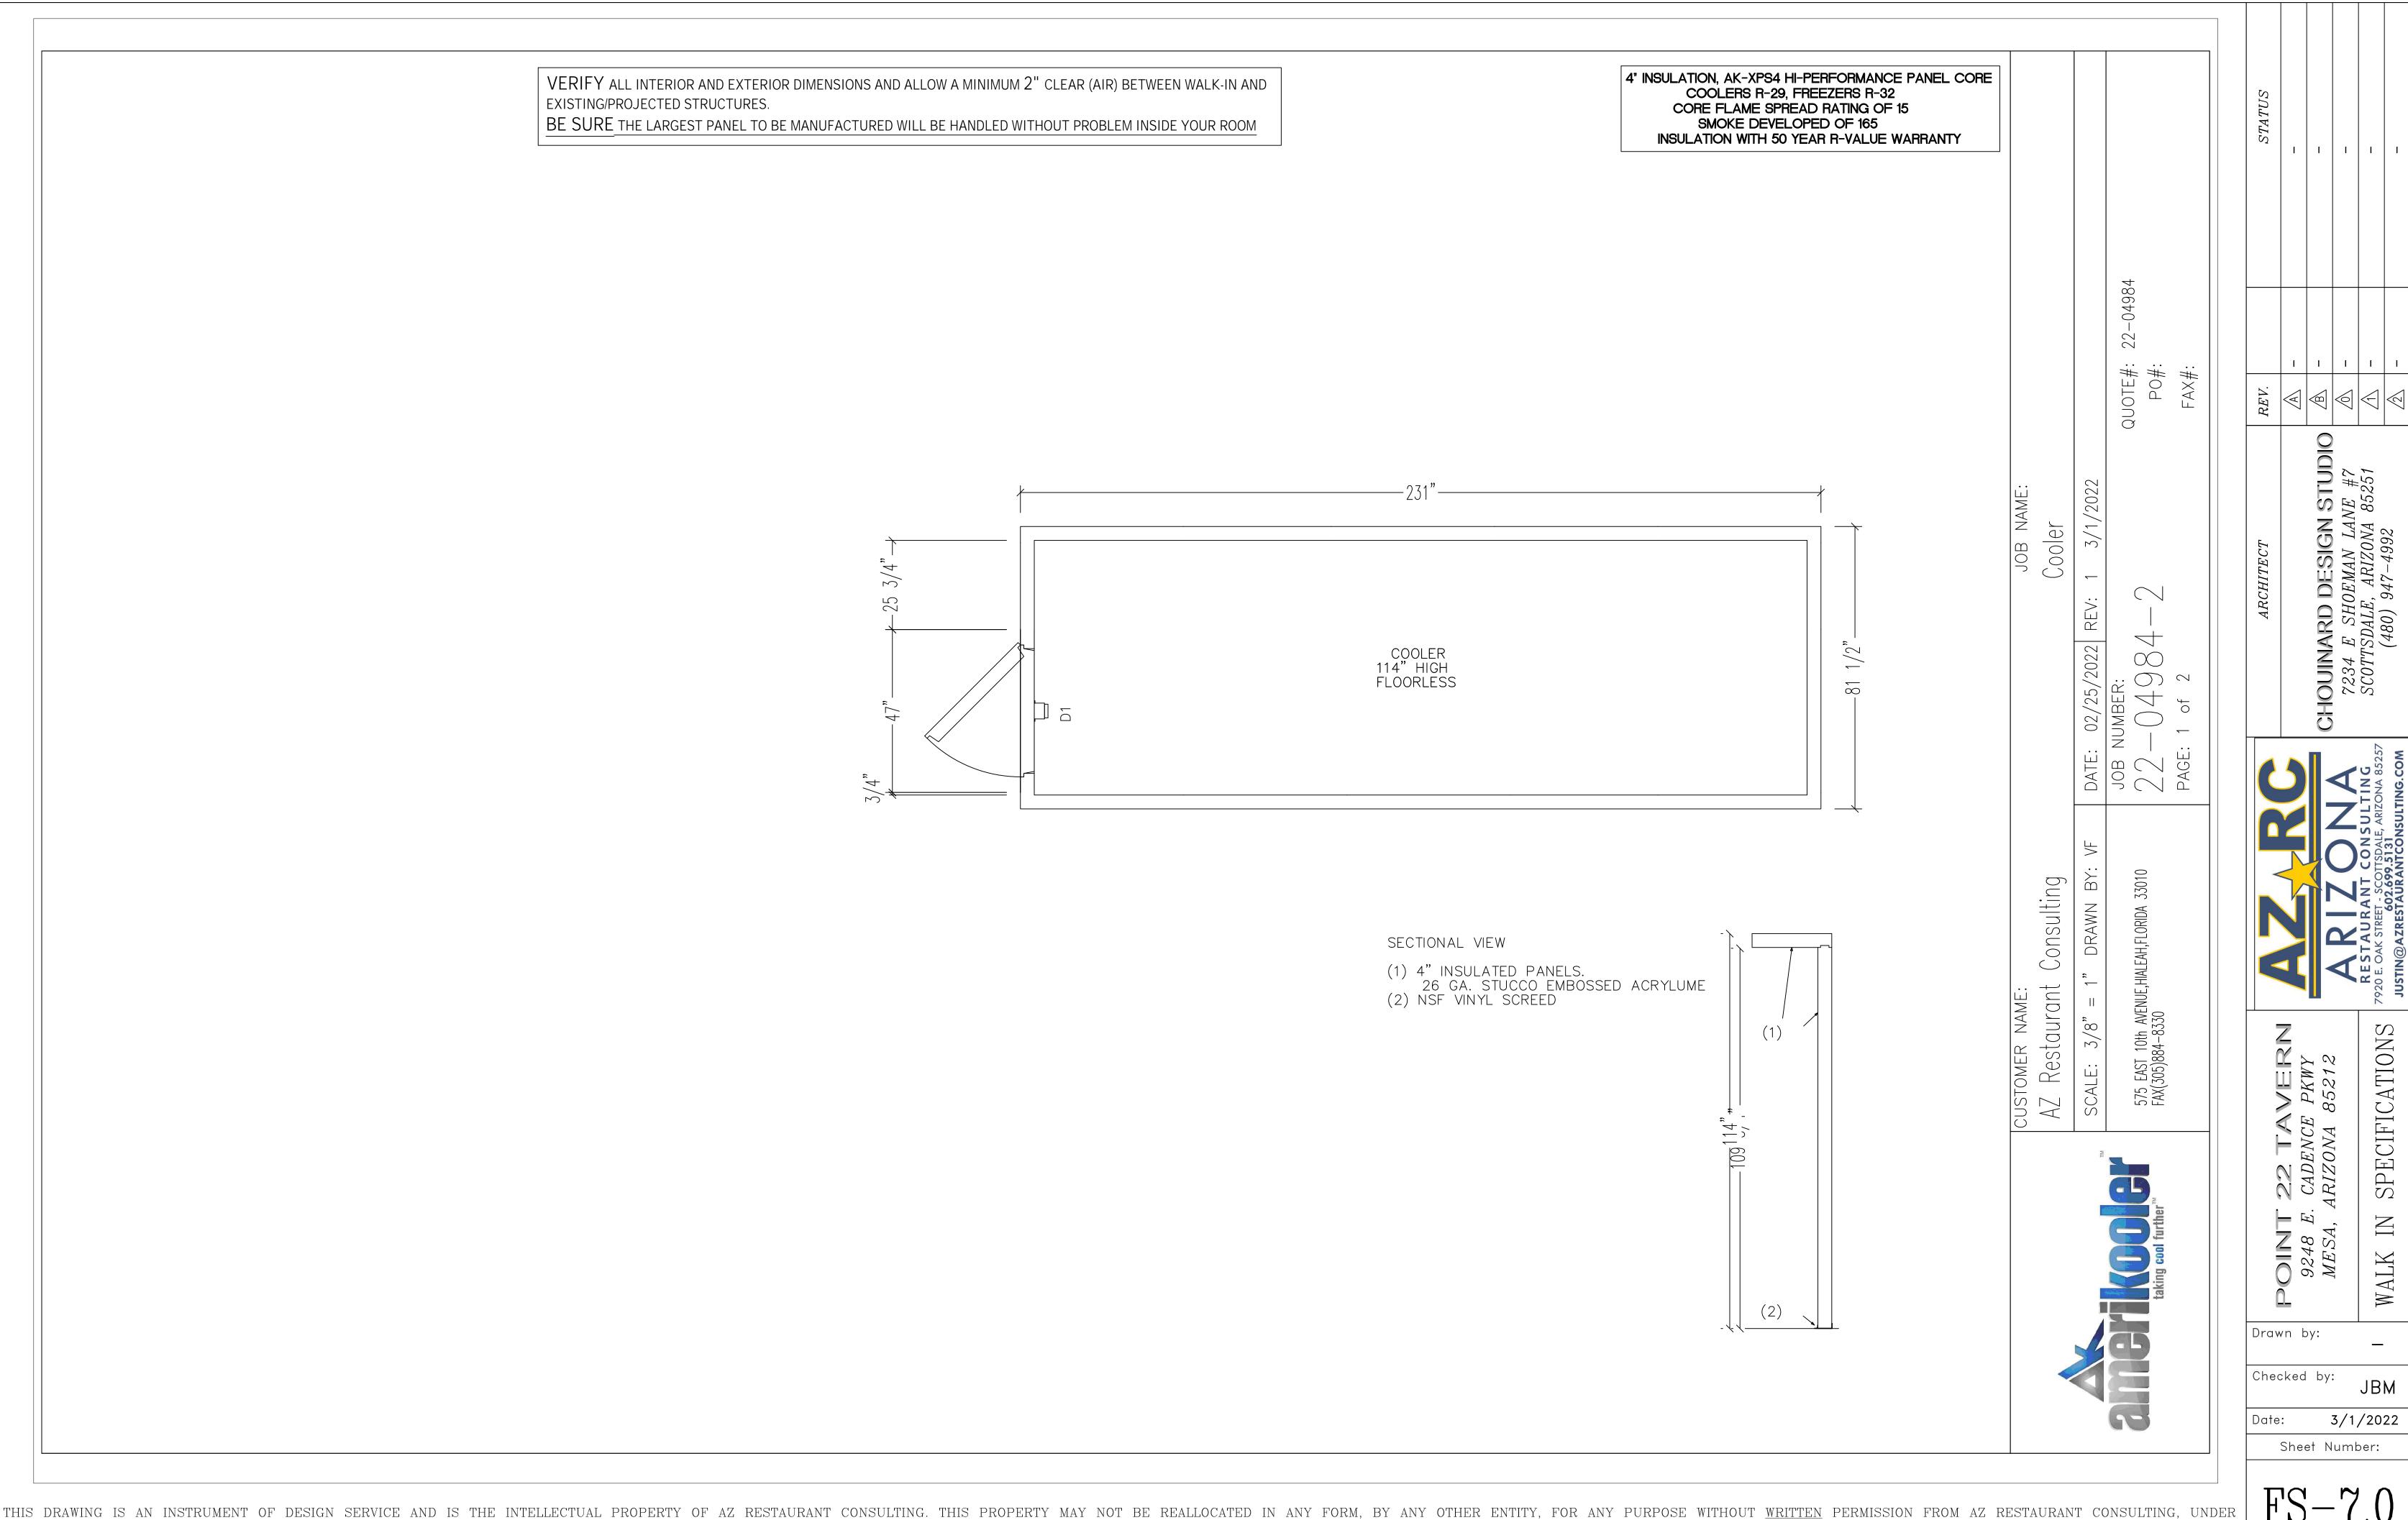




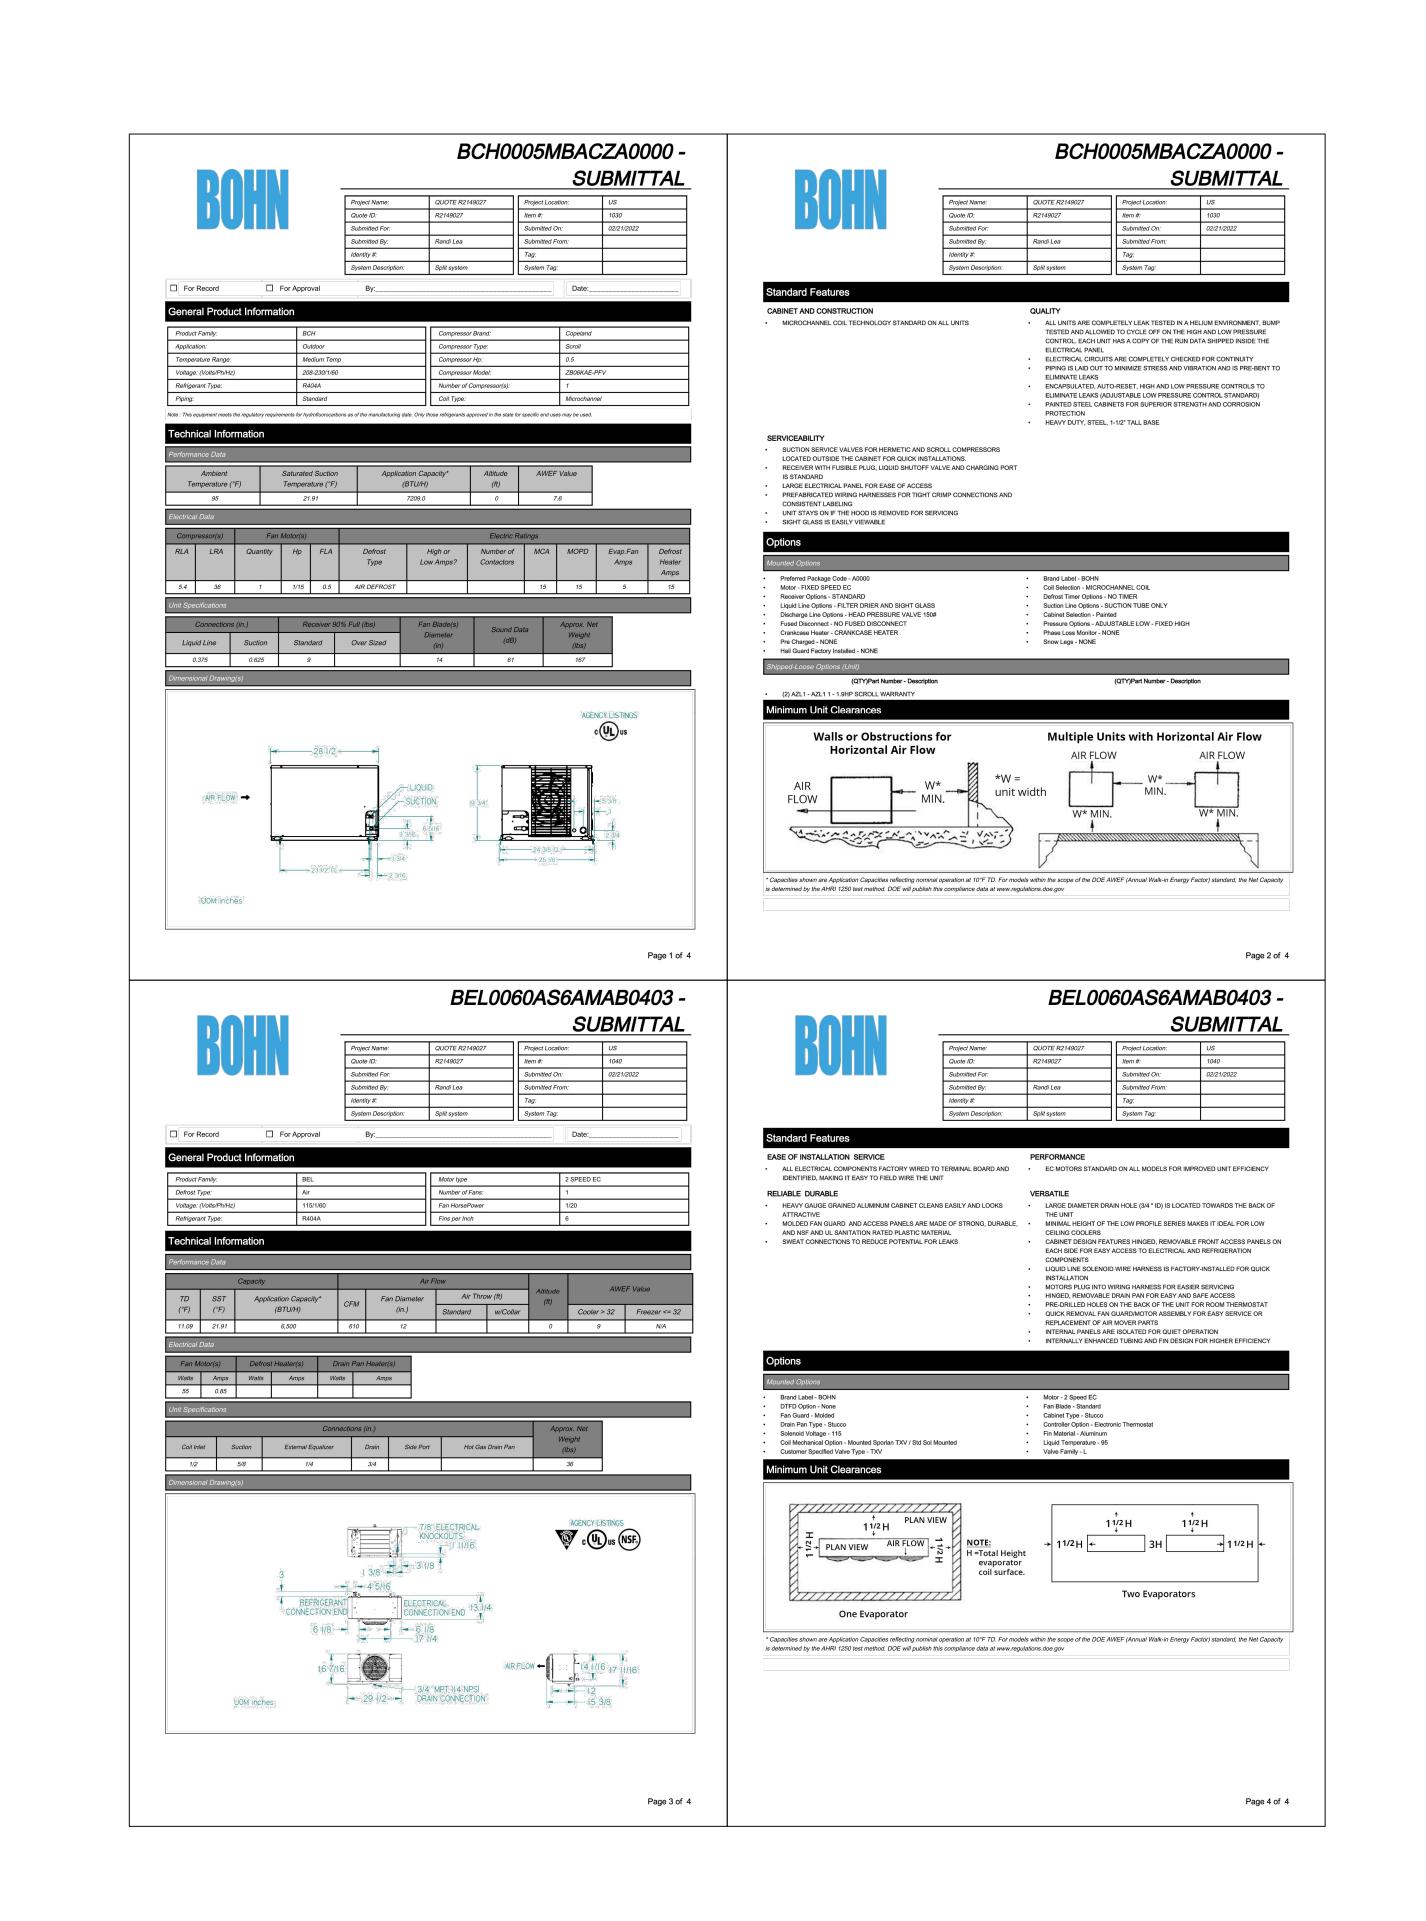


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SCOTTSDALE, ARIZONA 85251
(480) 947-4992 JOB N. Cooler 2022 /25/ BER 7 $\bigcup_{i \in I} f_i$ onsultin Restaurant ∞ \mathcal{O} 575 EAST 10tl FAX(305)884— SPECIFICATION cus. AZ CAD, RIZ E. OIINI 9248 MESA, ALK Drawn by: Checked by: 3/1/2022 Date: Sheet Number:

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